
# **RIGHTEOUS KITCHEN** 390 E. ST CHARLES ROAD LOMBARD, IL 60148

# DRAFTING SYMBOLS



#### DETAIL TITLE DESIGNATION

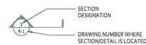

#### SECTION DESIGNATION






#### DETAIL DESIGNATION

ELEMENT NAME

101

1

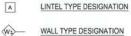





# REVISION NUMBER

# LINE TYPES

OBJECT LINE HIDDEN LINE (DENOTES SOMETHING LOCATED BELOW OR BEHIND) PHANTOM LINE (DENOTES SOMETHING LOCATED ABOVE OR IN FRONT) - CENTER LINE

### MATERIAL DESIGNATIONS

GYPSUM BOARD PRECAST CONCRETE

















BRICK MASONR

CONCRETE MASONRY UNIT



#### CONSTRUCTION NOTES

1. CONTRACTOR(S) SHALL VERIFY ALL NSIONS AND ALL CONDITIONS SHOWN ON DRAWINGS AT THE JOB SITE AND SHALL NOTIFY OWNER OF ANY DISCREPANCIES, OMISSIONS,

SHUTTING DOWN OF A BUILDING SYSTEM FOR THE TIE-IN OR ALTERATION PURPOSES SHALL BE COORDINATED WITH THE OWNER AND/OR GENERAL CONTRACTOR AS PER THEIR DIRECTION.

#### ACCESSIBILITY NOTES

- 1. ALL FIXTURES AND ACCESSORIES SHALL BE MOUNTED IN ACCORDANCE WITH ALL CITY/VILLAGE, A.D.A., ILLINOIS HANDICAP REGULATIONS AND ANSI, WHICHEVER IS MOST
- A.D.A., ILLINOIS HANDICAP REGULATIONS AND ANSI, WHICHEVER IS MOST STRINGENT.
- PROJECTING ACCESSORIES MUST BE LOCATED SO THEY WILL NOT INTERFERE WITH THE USE OF GRAB BARS AND WILL KEEP THE WHEELCHAIR AREA FREE.
- 4. EACH HANDICAP WASHROOM SHALL
- 5. ACCESSIBLE PARKING SHALL BE PROVIDED FOR THE TENANT SPACE WITH A MINIMUM \$250 FINE THE TENANT SPACE WITH A MINIMUM \$250 FINE FOR PARKING IN THE ACCESSIBLE PARKING SPACE.

# **GENERAL NOTES**

- THE GENERAL CONTRACTOR AND SUB-1. THE GENERAL CONTRACTOR AND SUB-CONTRACTORS, PRIOR TO SUBMITTING THEIR BID(S), SHALL FIELD SURVEY THE SITE OF PROPOSED WORK TO DETERMINE AND VERIFY THE EXTENT AND NATURE OF THIS
- 2. IF AT ANY TIME, PRIOR TO AND DURING CONSTRUCTION, A DISCREPANCY, OMISSION, AND/OR CONFLICT IS DISCOVERED, NOTIFY OWNER & ARCHITECT FOR CLARIFICATION AND/OR RESOLUTION
- THE GENERAL CONTRACTOR SHALL BE RESPONSIBLE FOR THE COST AND ACQUISITION OF ALL NECESSARY BUILDING PERMITS, PERMITS ARE TO BE POSTED ON JOB
- 4. DO NOT SCALE DRAWINGS, DIMENSIONS GOVERN. LARGE SCALE DETAILS GOVERN OVER SMALL SCALE PLANS, ELEVATIONS AND SECTIONS.
- 5. CONTRACTOR SHALL NOTIFY THE OWNER AND/OR BUILDING OWNER OF ANY UNFORESEEN JOB CONDITIONS WHICH MAY AFFECT PROJECT COST. EXTRA WORK AND/OR EXTRA COSTS MUST BE APPROVED IN TING PRIOR TO CONSTRUCTION OF SUCH
- 6. CONTRACTOR(S) SHALL NOT REMOVE ANY MATERIALS, (SIDELIGHTS, DOOR ASSEMBLIES, LIGHT FIXTURES, ETC.) FROM AREAS NOT IN CONTRACT (N.I.C.) UNLESS LLUSTRATED AS DEMOLITION AND NOTED AS RE-LOCATED IN THESE DOCUMENTS OR FROM BUILDING OWNER/MANAGEMENT TO
- TO ALL STATE AND LOCAL BUILDING CODES FOR WORK OF THIS TYPE.
- EXISTING, ALL REQUIRED WORK SHALL BE INCLUDED IN THE CONTRACT, WHETHER OR NOT SHOWN OR INDICATED.

### **GENERAL NOTES**

D. THE GENERAL CONTRACTOR SHALL PROVIDE ALL NECESSARY SAFE GUARDS, BARRIERS, TEMPORARY POWER, LIGHTING, FIRE PROTECTION, ETC., AS REQUIRED DURING DEMOLITION/CONSTRUCTION.

11. ALL CONTRACTORS ARE RESPONSIBLE FOR COORDINATION OF THEIR WORK WITH ALL OTHER TRADES, WORK SHALL BE PROPERLY SEQUENCED TO COINCIDE WITH THE PROJECT CONSTRUCTION SCHEDULE TO AVOID DELAY OF THE PROJECT OMPLETION OR THE WORK OF THE

- 2. THE GENERAL CONTRACTOR SHALL PROTECT AREA AND NEW OR EXISTING
  MATERIALS AND FINISHES FROM DAMAGE
  WHICH MAY OCCUR FROM CONSTRUCTION, WHICH MAY DILLUM FROM CONSTRUCTION DUST, WATER, ETC. DAMAGE TO EXISTING MATERIALS, FINISHES, STRUCTURE, AND EQUIPMENT SHALL BE REPARED OR REPLACED TO THE SATISFACTION OF THE TENANT AND THE BUILDING OWNER/MANAGEMENT AT THE EXPENSE OF THE GENERAL CONTRACTOR.
- ALL MATERIALS, METHODS OF 13. ALL MALERIUS, METHOUS OF CONSTRUCTION SYSTEMS (PARTITIONS, CEILINGS, DOORS, FRAMES, FLOORS, ETC.) SHALL CONFORM TO THE MANUFACTURERS' SPECIFICATIONS AND INSTALLATION INSTRUCTIONS FOR THE EXPECTED USE.
- 14. THE GENERAL CONTRACTOR SHALL REMOVE ALL RUBBISH AND WASTE MATERIALS OF ALL SUBCONTRACTORS AND TRADES ON A DAILY BASIS, AND SHALL EXERCISE STRICT CONTROL OVER JOB CLEANING TO PREVENT ANY DIRT, DEBRIS OR DUST FROM AFFECTING ANY FINE AREA, WHETHER WITHIN OR OUTSIDE THE

# **HEALTH DEPARTMENT**

EQUIPMENT NOTES:

3. ALL FOOD SERVICE EQUIPMENT IS TO BE
COMMERCIAL AND MEET THE STANDARDS
REGARDING DESIGN, MATERIALS, AND
WORKMANSHIP OF THE NATIONAL SANITATION
FOUNDATION INTERNATIONAL (SMS), AN NSF OR
OTHER RECOGNIZED TESTING AGENCY EQUIPMENT
MAY NOT MEET THE STANDARDS, AND REQUIRE
REPLACEMENT.

- INSTALL TARLE-MOUNTED FOLIPMENT ON A 2. INSTALL TABLE-MOUNTED EQUIPMENT ON 4" LEGS, OR SEAL THE EQUIPMENT TO THE TABLE USING SILICONE CAULK, UNLESS IT IS PORTABLE. PORTABLE EQUIPMENT SHALL WEIGHT LESS THAN 75 LBS, AND CONTAIN NO RIGID UTILITY CONNECTIONS. TABLE MOUNTED EQUIPMENT PIECES SHALL BE AT LEAST 6' APART FOR CLEANING
- 3. FLOOR MOUNTED EQUIPMENT SHALL BE INSTALLED (IF POSSIBLE) ON CASTERS, PROVIDE CASTERS FOR GRIDDLES, BROILERS, REACH IN REFRIGERATION COOLERS, BEVERAGE COOLER, RANGES, AND ALL COOKLINE EQUIPMENT. CASTER SHALL BE OF COATED STEEL, AND HAVE COMMERCIAL GRADE UTILITY CONNECTIONS THAT ARE SMOOTH AND FLEXIBLE WITH QUICK DISCONNECTS. CASTERS MUST MEET NSF STANDARDS. CONNECTIONS MUST BE LONG ENOUGH TO MOVE THE EQUIPMENT SO THAT THE AREA BEHIND EQUIPMENT CAN BE CLEANED.
- INSTALL EQUIPMENT, OTHER THAN PORTABLE 4. INSTALL EQUIPMENT, OTHER THAN PORTABLE COUIPMENT, WITH SUPFICIENT SPACE BETWEEN ADJACENT EQUIPMENT, FLOORS, WALLS, CABINETS, AND CEILINGS TO FACILITATE PROPER CLEANING. FLOOR-MOUNTED EQUIPMENT INSTALLED ON LEGS MUST HAVE A MINIMUM FLOOR CLEARANCE OF 6" CLEARANCE SHALL BE MEASURED FROM THE LOWEST OBSTRUCTION UNDER THE PIECE OF EQUIPMENT.

# FIRE DEPARTMENT

ELECTRICAL CONTRACTOR SHALL OF WORK PRIOR TO COMMENCEMENT OF DEMOLITION AND SHALL PROVIDE EMPORARY POWER AND LIGHTING FOR DEMOLITION CONTRACTOR

**ELECTRIC & PLUMBING** 

- ALL ELECTRICAL ITEMS BEING REMOVED SHALL BE DISCONNECTED AT THE CIRCUIT PANEL.
- ALL PLUMBING TO BE REMOVED SHALL BE CAPPED AT SOURCE.

- 2. PROVIDE ADDRESS PLAUDARDS READILYVISIBLE WITH CONTRASTING COLORS. NUMBERS SHALL BE MIN. 4" TALL AND MIN. STROKE WIDTH OF 1/2". LOCATE AT THE FRONT AND REAR ENTRANCES. IFC-505.1
- PORTABLE FIRE EXTINGUISHERS SHALL BE 3. POR IABLE FIRE EXTINGUISHERS SHALL E INSTALLED AND MAINTAINED IN ACCORDANCE WITH NFPA#10 AND IFC SEC. 906. INSTALL PRIOR TO FINAL INSPECTION
- FXIT SIGNS SHALL BE LOCATED AT THE RONT EXTERIOR EXIT DOORS AS PER IBO AS WELL AS AN OCCUPANCY PLAQUARD ALL ELECTRIC AND GAS APPLIANCES ARE

TO BE DE-ACTIVATED WITH THE ACTIVATION OF THE FIRE SUPPRESSION SYSTEM.

- PROVIDE ADDRESS PLAQUARDS

#### HEALTH DEPARTMENT HEALTH DEPARTMENT

THE EQUIPMENT'S DIMENSIONS DETERMINE THE PACE NEEDED FOR CLEANING ACCESS A. MAINTAIN 8" OF SPACING WHEN THE AREA TO BE LEANED IS LESS THAN & LONG MAINTAIN 18" OF SPACING WHEN THE AREA TO BE CLEANED IS 4' LONG OR GREATER.

- . 100% SILICONE CAULK SHALL BE USED TO SEAL LEANABLE TRIM AREAS INCLUDING SPACES IETWEEN NON-PORTABLE EQUIPMENT, ACCESS TO CABINET VOIDS, AROUND PIPES, AND WALL-MOUNTED EQUIPMENT. THE SILICONE BEAD MUST BE SMOOTHED AND COVED 3/8" RADIUS.
- WALL INTERFACES THAT ARE LARGER THAN 1/32' AND SMALLER THAN 6". SEAL ALL GAPS, VOIDS AND PROTRUSIONS USING SILICONE CAULK OR FRIM THAT MEETS THE FINISH MATERIAL
- 9. ALL SINKS FOR EMPLOYEE OR PUBLIC USE (OTHER THAN LAVATORY SINKS) SHALL BEA MAXIMUM OF 6 1/2" DEEP AND MOUNTED WITH TH TOP EDGE A MAXIMUM OF 34" ABOVE THE FLOOR.

#### STORAGE AREA NOTES:

ALL KITCHEN SHELVING MUST MEET NSF TANDARDS, SHELVES SHALL BE CONSTRUCTED OF METAL OR MATERIAL WHICH HAS BEEN FINISHED SO AS TO HAVE SMOOTH, EASILY CLEANABLE, NON-ABSORBANT SURFACES. SHELVES SUBJECT TO HEAT OR MOISTURE MUST BE OF RUST-RESISTANT METAL OR COATED.

2. ALL SHELVING IN REFRIGERATORS AND FREEZERS MUST MEET NSF STANDARDS. ALL SHELVING INSTALLED IN REFRIGERATORS MUST BE RUST-RESISTANT METAL OR OTHER IMPERVIOUS MATERIAL. THE MAXIMUM HEIGHT OF A BOTTOM SHELF ABOVE THE FLOOR OF A WALK-IN COOLER AND FREEZER IS &\*

. FOOD PREPARATION AND UTENSIL WASHING REAS MUST BE WELL LIT. A LIGHT INTENSITY OF 100 FOOTCANDLES MEASURED 30" ABOVE THE LOOR IS REQUIRED.

MUST PROVIDE AT LEAST 50 FOOTCANDLES OF LIGHT THROUGHOUT. INSTALL TWO INCANCESCENT LIGHTS OR FLUORESCENT LIGHTS WITH VAPOR-PROOF LENSES. INSTALL LIGHTING SO THAT FIXTURE WILL NOT BE OBSTRUCTED BY

# KITCHEN & COOKLINE FINISH NOTES: .. ALL FLOOR FINISHES IN FOOD PREP AND FOOD TORAGE AREAS SHALL BE OF DURABLE

GREASE-RESISTANT AND EASILY CLEANABLE MATERIAL. SEE ROOM FINISH SCHEDULE FOR TILE LOCATION. PREP FLOOR FOR TILE APPLICATION. TILE BASE TO MATCH FLOOR MATERIAL.

- OF THE FLOOR AND WALL OR CABINET. COVING SHALL HAVE 3/8" RADIUS.
- 3. ALL WALLS TO HAVE A SMOOTH AND EASILY CLEANABLE SURFACE THAT HAS A LIGHT-COLORED FINISH. PROVIDE RIBERGLASS REINFORCED PANELS (FRP) AS SHOWN ON DRAWINGS AND ROOM FINISH SCHEDULE.
- ALL CEILING FINISHES IN FOOD PREP AND FOOD 4. ALL CEILING FINISHES IN FOOD PREP AND F STORAGE AREAS SHALL BE SMOOTH, NON ABSORBENT, VINYL FACED, LIGHT COLORED CEILING PANELS: PANEL MUST BE WASHABLE EXPOSED JOINTS, STUDS, OR OTHER SUPPORT STRUCTURES ARE NOT ACEPTABLE.

REFLECTED CEILING PLAN NOTES

1. ALL CEILING HEIGHTS AND FINISHES TO REMAIN
AS-IS. ONLY AREAS RENOVATED SHALL BE MEETTC
CURRENT CONDITIONS. REFER TO ROOM FINISH SCHEDULE FOR EXISTING CEILING HEIGHTS AND EXISTING CEILING FINISHES.

- COORDINATE WITH FLECTRICAL AND MECHANICAL CONTRACTORS FOR NEW LOCATIONS (IN RENOVATED AREAS ONLY) OF AIR DIFFUSERS, SPRINKLER HEADS, AND LIGHTING FIXTURE RELOCATIONS/INSTALLATIONS
- . SEE ROOM FINISH SCHEDULE FOR ALL PAINTING REQUIREMENTS. PAINT ALL NEW GYPSUM BOARD CEILINGS AND SOFFITS.

# DRAWING SHEET INDEX

# DWG.No. DRAWING TITLE ARCHITECTURAL

A-0.0 COVER PAGE, GENERAL NOTES, CODE INFO FLOOR PLANS, DEMO PLAN, EQUIPMENT SCHEDULE A-1.0 DOOR SCHEDULE, ROOM FINISH SCHEDULE WALL TYPES, DETAILS

# MECHANICAL

M-1.0 REFLECTED CEILING PLAN, VENTILATION SCHEDULE SHEET 1 CAPTIVE AIRE HOOD DRAWINGS CAPTIVE AIRE HOOD DRAWINGS SHEET 2 CAPTIVE AIRE HOOD DRAWINGS SHEET 3 SHEET 4 CAPTIVE AIRE HOOD DRAWINGS

# CAPTIVE AIRE HOOD DRAWINGS CAPTIVE AIRE HOOD DRAWINGS **ELECTRICAL**


ELECTRICAL POWER PLAN, LIGHTING PLAN F-1.0 PANEL SCHEDULE RISER DIAGRAM, NOTES E-1.1 ELECTRICAL LIGHTING PLAN, NOTES

# **PLUMBING** GAS/PLUMBING PLAN, FIXTURE SCHEDULE

SHEET 5

P-1 1

# PLUMBING DETAILS LOCATION MAP

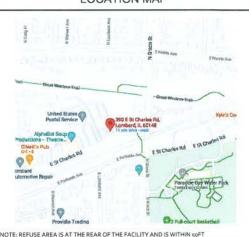

### **BUILDING CODE ANALYSIS**

TOTAL SQ. FT OF BUILD-OUT

CONSTRUCTION TYPE CONSTRUCTION TYPE FIRE SUPPRESSION FIRE RATING OF STRUCTURE USE GROUP ADJACENT USE GROUP DEMISING PARTITIONS

TOTAL SO, FT OF BUILD-OUT

OCCUPANCY CALCULATION

EGRESS - MAX TRAVEL DISTANCE

OHOURS
OHOURS
(M) MERCANTILE
(M) MERCANTILE
1 HR RATE)
2018 International Building Code
2018 International Residential Code
2018 International Florey Conservation Code
2018 International Florey Conservation Code
2018 International Florey Conservation Code
2018 International Mechanical Code 2018 International Mechanical Code 2018 International Property Maintenance Code 2017 National Electric Code 2014 Illinois State Plumbing Code 2018 International Fire Code

OCCUPANCY CALCULATION EGRESS -MAX TRAVEL DISTANCE NFPA 13 – 2016 Fire Sprinkler Code NFPA 72 – 2016 Fire Alarm Code 2018 Illinois Accessibility Code 2010 Federal ADA Standard 2010 rederal AUA Standards
Elevator Code as adopted by the State of Illinois
2015 NFPA 101 Life Safety Code
2005 (CZ/RAS) A117,15 Standard for Accessible & Usable
Buildings & Facilities
Accessibility Denuisopments of Enix Mouving Act Buildings & Facilities
Accessibility Requirements of Fair Housing Act
Lombard Municipal Code Chapter 150: Building Code
Lombard Municipal Code Chapter 152: Goning Ordinance
Lombard Municipal Code Chapter 154: Subdivision &

Development Ordinance Lombard Municipal Code Chapter 153: Sign Ordinance

INTERIOR BUILD-OUT TO EXISTING MERCANTILE UNIT CORRIDORS-CLASS II (0-75 FLAME SPREAD)
OTHER SPACES- CLASS III (76-200 FLAME SPREAD)

KITCHEN AREA = 1686 NET/200 SF PER PERSON BUSINESS/AUXILIARY SPACE = 750/100 MAX OCCUPANCY

# STATEMENT OF COMPLIANCE

HAVE PREPARED. OR CAUSED TO BE PREPARED UNDER MY DIRECT SUPERVISION, THE ATTACHED



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NOTE TO BUILDING

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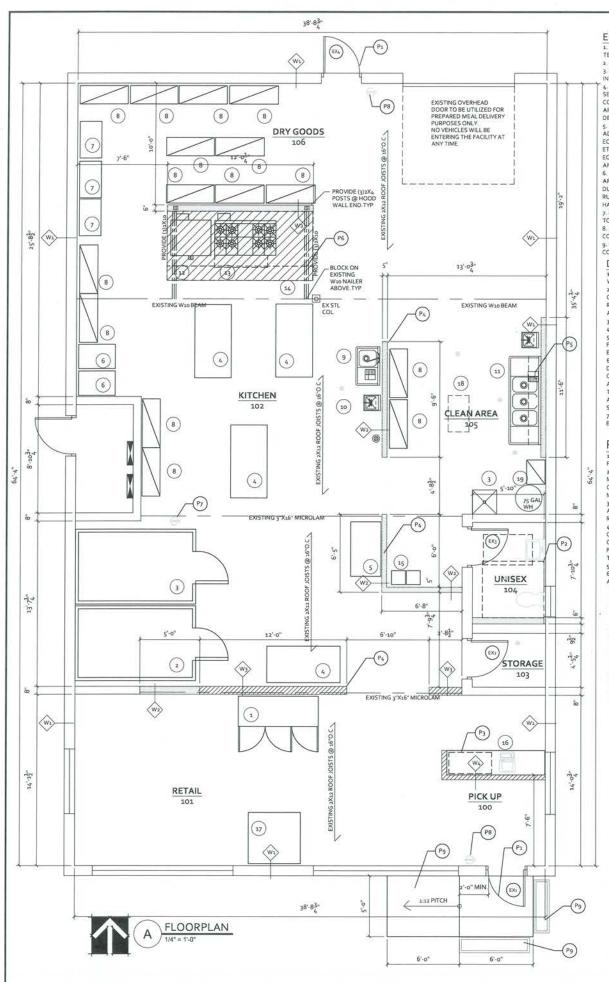
ROAD TEOUS KITCHEN E LOCATED AT ST CHARLES RO ARD, IL RIGHTE TO BE 390 E.





SHEET NUMBER

A-0.0



#### **EQUIPMENT SCHEDULE NOTES:**

- 1. FINAL LENGTH OF SHELVING TO BE DETERMINED IN THE FIELD BY THE
- GALVANIZE UNDER SHELVES ARE NOT ALLOWED
- GALVANIZE UNDER SHELVES ARE NOT ALLOWED
   SEMERAL CONTRACTOR TO INCLUDE IN BID ALL EQUIPMENT
   INSTALLATION AND CONNECTIONS
   COUPMENT TO BE INSTALLED BY A QUALIFIED EQUIPMENT INSTALLER-
- SEE DRWINGS PREPARED BY EQUIPMENT VENDER FOR INSTALLATION AND CONNECTION REQUIREMENTS. ALL EQUIPMENT AND SHELVING TO BE NSF APPROVED. USE EQUIPMENT MUST BE APPROVED BY THE COUNTY HEALTH S. SEE ELECTRICL, MECHANICAL, AND PLUMBING DRAWINGS FOR
- ADDITIONAL EQUIPMENT REQUIREMENTS. ALL EQUIPMENT CONNECTIONS, EQUIPMENT VOLTAGE, AMPAGE AND PHASE, GAS, WATER CONNECTION ETC. TO BE CONFIRMED WITH FINAL EQUIPMENT SELECTION. VERIFY EXACT EQUIPMENT REQUIREMENTS AND CONNECTIONS WITH TENANT PRIOR TO ANY ROUGH IN WORK.
- 6. ANY USED EQUIPMENT INCLUDING SMALLWARES MUST BE NSF APPROVED, CLEAN, OPERABLE, AND SUBJECT TO FINAL APPROVAL BY THE DUPAGE COUNTY HEALTH DEPARTMENT, ALL EQUIPMENT MUST BE FREE OF RUST AND DEBRIS, AND IN LIKE NEW CONDITION. ALL REFRIGERATION MUST HAVE DATA PLATES AND BE NSF STANDARD 7 COMPLIANT.
  7. ITEMS (COOKLINE EQUIPMENT & REACH IN REFRIGERATION UNITS) ALL
- TO BE INSTALLED ON CASTERS 8. PROVIDE NSF APPROVED OPEN WIRE DUNNAGE RACKS IN THE WALK IN
- COOLER WHERE APPLICABLE

  9. GAS EQUIPMENT TO BE INSTALLED WITH A QUICK DISCONNECT HOSE CONNECTION AND RESTRAINING DEVICE.

# DOOR NOTES:

- 1. VERIFY ALL EXIT DOORS ARE OPERABLE FROM THE INSIDE BY A LEVER WITHOUT THE USE OF A KEY.
- VERIFY ALL DOOR AND HARDWARE SHALL COMPLY WITH THE STATE OF ILLINOIS ACCESSIBILITY STANDARDS AND ADA REQUIREMENTS. REPLACE EXISTING HARDWARE IF REQUIRED TO COMPLY WITH STATE AND FEDERAL REQUIREMENTS
- AND FEDERAL REQUIREMENTS.
  3. REPAINT ALL HOLLOW METAL DOOR AND FRAMES IF NECESSARY.
  4. RESTAIN ALL WOOD DOORS IF NECESSARY
  5. EXISTING EXTERIOR ENTRY DOORS TO BE SELF CLOSING AND TIGHT
- FITTING. ADD NEW THRESHOLD AND SWEEPS IF NECESSARY TO PREVENT ENTRANCE OF INSECTS AND RODENTS.

  6. ALL DOOR HANDLES, PULLS, LATCHES, LOCKS AND OTHER OPERATING
- DEVICES SHALL BE INSTALLED BETWEEN 34" AND 48" A.F.F. THE OPERATING DEVICES SHALL BE CAPABLE OF OPERATION WITH ONE HAND AND SHALL NOT REQUIRE TIGHT GRASPING, TIGHT PINCHING, OR TWISTING OF THE WRIST TO OPERATE. ALL EXIT DOORS SHALL SWING AND MEET THE MAXIMUM OPENING FORCES REQ. IN ACCORDANCE WITH
- SECTION, (1003.3.1.8.3)
  7. VERIEV EXISTING PANIC HARDWARE AND WEATHERSTRIPPING AT EXTERIOR DOORS WHERE REQUIRED.

### **ROOM FINISH NOTES:**

- 1. ALL INTERIOR WALL FINISHES SHALL NOT BE LESS THAN CLASS II FINISHES AS CLASSIFIED IN ACCORDANCE WITH ASTM E84 FINISHES AS CLASSIFIED IN ACCORDANCE WITH ASTME 84,
  2. ALL INTERIOR FLOOR FINISHES SHALL NOT BE LESS THAN CLASS II
  MATERIALS PER ASTM E648. INTERIOR FLOOR FINISHES SHALL
  COMPLY WITH THE DOC FF-1 "PILL TEST" (CPSC 16 PART 1630). MINIMUM CRITICAL RADIANT FLUX OF .O4 WATTS/CM3
- ALL INTERIOR WALL AND CEILING FINISHES SHALL HAVE A FLAME 3. ALL INTERIOR WALL AND CEILING FINISHES SHALL HAVE A FLAME
  AND SMOKE RATING NOT GREATER THAN DESIGNATED BY THE
  REQUIRED CLASSIFICATION.
  4. PROVIDE LIGHT COLORED FRP PANELING WITHIN KITCHEN AREA.
- ON NEW GYPSUM WALLS FROM FLOOR LEVEL UP TO EXISTING CEILING HEIGHT, LITHLIZE PROPER CONNECTION/TERMINATION
- 5. KEEP ALL COLORS LIGHT COLORED SEMI-GLOSS PAINT ANY SOILED OR DAMAGED FLOOR, WALL, AND CEILING FINISHES ARE TO BE REPLACED OR REPAIRED TO BE IN LIKE NEW CONDITION

# FINISH ABBREVIATIONS:

GYP. BD. = 16" TYPE 'X' GYPSUM BOARD WRGB = 8° TYPE 'X' WATER RESISTANT GYPSUM

BOARD PT = PAINT FINISH

VB = RUBBER BASE

CONC = EXISTING EPOXY COATED CONC FLOOR TO REMAIN REPAIR ANY NEW AREAS TO MATCH ACC1 = USG "CLEANROOM CLIMAPLUS" VINYL

COATED 2X4 TILES
PT/FRP = FIBERGLASS REINFORCED PANELS UP 9'-0"

EX CMU= EXISTING PAINTED CMU TO REMAIN

#### **FLOORPLAN NOTES**

# P1. EXISTING ENTRY/REAR DOORS, NO WORK ANTICIPATED.

P3. PROVIDE NEW CARPENTER BUILT FRONT TRANSACTION COUNTER. ALL SUBFACES TO MET HEALTH DEPARTMENT REQUIREMENTS. ANY WOOD TO BE SEALED OR COATED. MAX COUNTER HEIGHT TO BE 34" AFF.

P4. NEW WALL AS SHOWN-SEE WALL DETAILS - TYPICAL NON-LOAD BEARING INTERIOR PARTITION. 3-5/8" METAL STUDS W/5/8" TYPE X GYPSUM ON EACH SIDE. PROVIDE GREEN BOARD AT ANY WET WALL LOCATIONS.

P5. ALL SHELVING TO BE HUNG TO EXISTING/NEW WALLS WITH PROPER HEAVY DUTY ANCHORS GIVEN WALL MATERIAL. ANY NEW WALLS SHALL BE PROVIDED WITH 1/2" FIRE RATED PLYWOOD INSIDE WALL CAUTY FOR


P6. NEW TYPE 1 HOOD INSTALLATION. SEE HOOD DRAWINGS FOR P6, NEW 17PE 1 HOOD INSTALLATION. SEE HOOD DRAWINGS FOR FURTHER INFO. CONTRACTOR TO PROVIDE STAINLESS STEEL BACKSPLASH BEHIND HOOD FROM FLOOR UP TO UNDERSIDE OF HOOD, HOOD CANOPY TO EXTEND PAST EQUIPMENT MIN. 6".

P7. TYPE K FIRE EXTINGUISHER-FINAL LOCATION DETERMINED IN FIELD WITH FIRE MARSHALL.

P8. TYPE ABC FIRE EXTINGUISHER- FINAL LOCATION DETERMINED IN

#### Pg. OWNER PROVIDED PLANTERS

P10. CONTRACTOR TO SAWCUT EXISTING ASPHALT AT NEW CONCRETE STOOP AND SLOPED WALKWAY. CURRENTLY FINISH FLOOR TO OUTDOOR PAVEMENT IS APPROX.938". PROVIDE 6FT LENGTH MIN OF SLOPED PAVEMENT TO EXISTING ASPHALT PARKING AREA. CONCRETE SHALL BE 4000PSI MIN FIBER MESH REINFORCED. PROVIDE BROOM FINISH

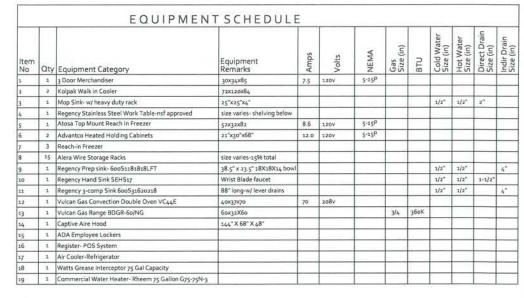

					DOO	R SCHE	DULE		=-4
	SI	ZE	D	OOR		FRAME		HARDWARE	REMARKS
MARK	WIDTH	HEIGHT	TYPE	MATERIAL	TYPE	MATERIAL	DEPTH	SET	
EX1	3'-0"	7'-0"	В	GL/ALUM	1	ALUM	4-1/8"	EX	EXISTING DOOR- VERIFY WORKING ADA HARDWARE
EX2	3'-0"	7'-0"	Α	WDSC	1	MTL	5-1/8"	EX	VERIFY ADA LEVER HARDWARE
EX3	3'-0"	7'-0"	BA	WDSC		MTL	5-1/6"	EX	VERIFY ADA LEVER HARDWARE
EX4	3'-0"	7'-0"	С	HMI	- 1	STL	5-1/6"	EX	REPAIR/REPLACE DOOR

### DOOR HARDWARE

GROUP 1
1/2" PAIR BUTT HINGES
1-1/2" PAIR BUTT HINGES
1-1/2" PAIR BUTT HINGES
ADA LEVER TYPE HANDLE
PRIVACY LOCKSET
KEYED LOCKSET

#### DOOR SCHEDULE ABBREVIATIONS

HOLLOW METAL DOOR INSULATED HOLLOW METAL EXTERIOR DOORS BIRCH VENEER WOOD - SOLID CORE FULL LITE GLASS AND ALUMINUM DOOR


#### DOOR SCHEDULE NOTES:


- 1. ALL DOORS SHALL BE 1 3/4" THICK UNLESS NOTED OTHERWISE
  2. PROVIDE WALL BUMPERS OR FLOOR STOPS FOR ALL SWINGING DOORS
  3. ADA LEVER HANDWARE ON ALL DOOR WIS WAINELED HARDWARE INTO HAZARD
  4. ALL EGRESS DOORS SHALL UTILIZE KEYLESS LOCKSETS AND BE READILY OPEN
  5. NO FLUSH BOLTS, DEAD OR DRAW BOLTS ARE ALLOWED.
  6. OPERATING PRESSURE OF DOORS:
  EXTERIOR: MAX 8,9"
  MITERIOR: MAX 8,9"
  MITERIOR: MAX 9,9"

- INTERIOR: MAR 5,00"

  DOOR THESHOLD SHALL NOT EXCEED 1/2" IN HEIGHT. THRESHOLDS EXCEEDING 1/2" IN HEIGHT SHALL HAVE A 112 BEVEL.

  8. ALL GLAZING FOR ENTRY DOOR AND SIDELIGHT SHALL BE TEMPERED GLASS.
- 9. INSULATED METAL EXTERIOR DOORS SHALL HAVE MIN U-FACTOR .45 OR BETTER

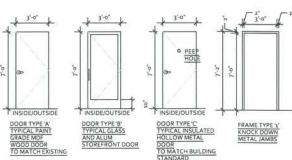

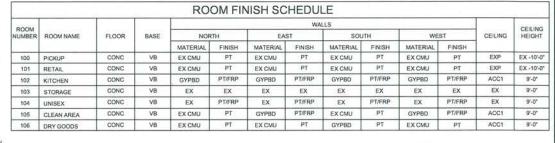

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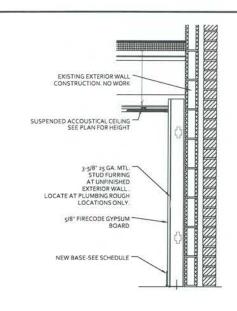
ROAD INTERIOR REMODEL RIGHTEOUS KITCHEN TO BE LOCATED AT 390 E. ST CHARLES RO/ LOMBARD, IL






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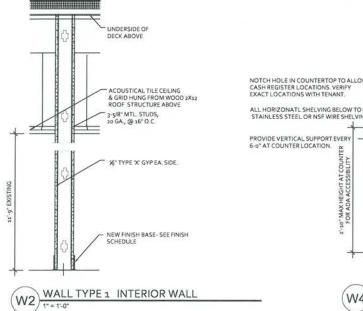
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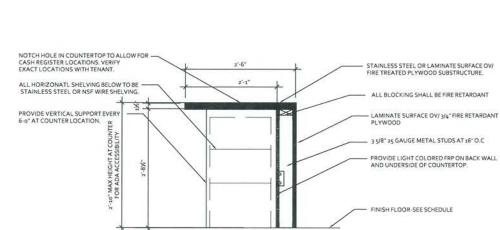





W1) WALL TYPE 1 EXISTING EXTERIOR WALL

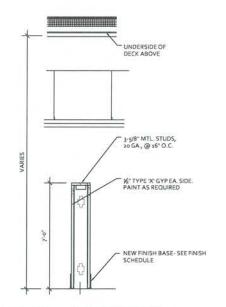
WALL TYPE 2 INTERIOR WALLS





WALL TYPE 3 COUNTER HALFWALL

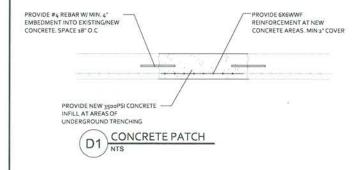

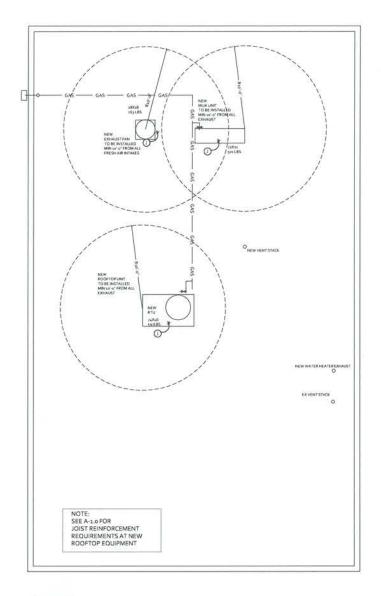



ISSUES AND REVISIONS:

NO. BY. DATE. DESCRIPTION.

1 86 2-5-22 8ID PLANS

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INTERIOR REMODEL RIGHTEOUS KITCHEN TO BE LOCATED AT 390 E. ST CHARLES ROAD LOMBARD, IL



ONE TRANS AM PLAZA DRIVE SUITE #120 OAKEROOK TERRACE IL 60181 PHONE: 708-508-7281


PROJECT ARCHITECT:	DATE:
BG	2-5-22
DRAFTPERSON:	SCALE:
BG	See Sheet
APPROVED:	COMPUTER NA
APPROVED:	ARCL'S
	DULD STATE
	14
LOCATION : 003 390 E. ST CHARLES RO LOMBARD, IL JOB NUMBER :	-021417 # E
390 E. ST CHARLES RO	OF LLINGS
LOMBAND, IL	OF ILLIANDER
JOB NUMBER	OF ILLIN

SHEET NUMBER

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A-1.1 of



#### LEGEND

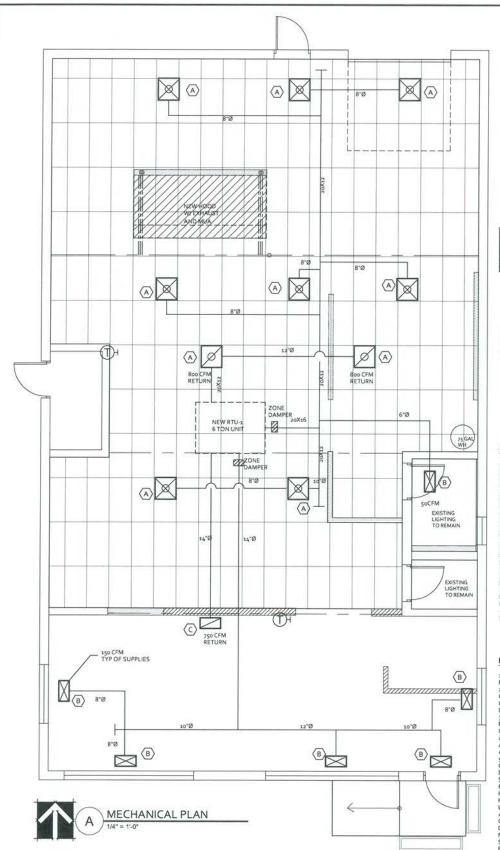

EXIT SIGN/EM COMBO UNIT WITH 90 MIN BATTERY BACK-UP. MAX 5WATTS PER SIDE

EXIT SIGN WITH 90 MIN. BATTERY BACK-UP. MAX 5WATTS PER SIDE (2)

EMERGENCY LIGHTING W/ 90 MIN 9EP

FIRE EXTINGUISHER

DUPLEX OUTLET

130V QUAD OUTLET

DEDICATED OUTLET

110V RECESSED FLOOR OUTLET

DATA/PHONE OUTLET PROVIDE 3/4" CONDUIT STUB UP ABOVE CEILING- LOW VOLTAGE INSTALL BY OTHERS.

2'X4' 120V 35W LAY-IN LED LIGHT FIXTURE WITH COVERED LENSES-REPLACE EXISTING FIXTURES WITH NEW, ADJUST LOCATION AS NEEDED

O 6" LED CAN LIGHT 13W

50CFM EXHAUST FAN UNIT



NEW HVAC SUPPLY DIFFUSER



NEW HVAC RETURN DIFFUSER



OS OCCUPANCY SENSOR-VERIFY/PROVIDE AT EXISTING RESTROOM/JAN CLOSET STORAGE ROOMS

#### NOTE TO HVAC CONTRACTOR:

-HVAC DUCT SIZING AND LAYOUT SHOWN IS FOR GENERAL PURPOSES ONLY. IT SHALL BE THE RESPONSIBILITY OF THE HVAC CONTRACTOR TO VERIFY DUCT SIZING AND APPROPRIATE LENGTHS FOR REQUIRED CFM OUTPUT ON ANY ADDED RETURNISUPPLY REGISTERS (IF APPLICABLE-SEE PLANS). CONSULT ARCHITECT WITH ANY DISREPENCES OR FIELD CONDITIONS THAT EXISTING WHICH MAY ALTER DESIGN

OR FIELD CONDITIONS THAT EXISTING WHICH MAY ALTER DESIGN SHOWN ABOVE.

NEW RITU TO BE INSTALLED.

NAMIN DUCTWORK WITHIN UNIT AT CEILING LEVEL TO REMAIN AS IS.

ADJUST LOCATION OF NEW BRANCH SUPPLYRETURNS ONLY AS.

REDED FOR NEW ROOM CONFIGURATIONS.

BALLANCE UNITS FOR REQUIRED FRESH AIR INTAKE TO MEET OR EXCEED THOSE AMOUNTS SHOWN IN TABLE 409.3. TEST AND BALLANCE REPORT REQUIRED AND SUBMITTED TO CITY/VILLAGE FOR APPROVAL AN ECONOMIZET.

ECONOMIZER
WILL BE REQUIRED AND/OR MUA UNIT ADJUSTED ON HOOD TO SUPPLY
ADDITIONAL HEATED MUA TO COMPENSATE FOR THE FRESH AIR
REQUIREMENT FOR SPACE.
-VERIFY EXISTING BATHROOM EXHAUST FAN DUCTS TERMINATE AT
ROOFLINE WITH PROPER RAINCAPS AND WITHIN MIN. 10FT FROM ANY RTU INTAKES

GENERAL EXHAUST FOR KITCHEN SPACE AS REQUIRED PER IMC TO BE SUPPLIED THROUGH ADDITIONAL EXHAUST AT NEW HOOD

# HOOD/MECHANICAL NOTES

 THE CANOPY OF THE HOODS SHALL EXTEND OR OVERHANG THE EQUIPMENT BEING SERVED BY THE HOD BY AT LEAST 6". IMC 507.12
 VERTICAL AND HORIZONTAL GREASE DUCTS REQUIRE CLEANOUT AND OPENINGS WITH TIGHT FITTING DOORS AND SASKETS/SEALING MATERIALS RATED FOR NOT LESS THAN 1,500

DEGREES FAHRENHEIT.
3, PORTABLE CLASS K RATED FIRE EXTINGUISHERS SHALL BE PROVIDED WITHIN 30FT TRAVEL DISTANCE OF COMMERCIAL TYPE COOKING EQUIPMENT INVOLVING VEGETABLE OR ANIMAL OILS AND EATS.

ND FATS. THE OPENING OF THE EXHAUST ON THE ROOF SHALL BE PLACED. 4. THE OPENING OF THE EXHAUST ON THE ROOF SHALL BE PLACED AT LEAST, or ABOVE THE ROOF SURFACE.

5. PRIOR TO THE USE OR CONCEALMENT OF ANY PORTION OF A GREASE DUCT SYSTEM, A LEAKAGE TEST SHALL BE PERFORMED. DUCTS SHALL BE CONSIDERED CONCEALED WHERE INSTALLED IN A SHAFT OR COVERED BY CONTINGS OR WRAPS.

5. HAF FOLLOWING TESTING/INSPECTIONS SHALL OCCUR FOR THE

HOOD SYSTEM. THE LOCAL OFFICIAL SHALL HAVE A MINIMUM OF 48 HOURS NOTICE OF THE TEST. THEY SHALL INCLUDE BUT ARE NOT

LIMITED TO: A- A PERFORMANCE TEST SHALL BE CONDUCTED UPON COMPLETION AND BEFORE FINAL APPROVAL OF THE HOOD AND DUCT SYSTEM. THIS TEST SHALL VERIFY THE EXHAUST AIRFLOW, MAKEUP AIRFLOW, CAPTURE AND CONTAINMENT OF THE EXHAUST

MAKEUP AINTLOW, CAPTURE AND CONTAINMENT OF THE EXHAUST SYSTEM.

B- A CAPTURE AND CONTAINMENT FIELD TEST SHALL BE
B- A CAPTURE AND CONTAINMENT FIELD TEST SHALL BE
CONDUCTED WITH ALL APPLIANCES UNDER THE HOOD.
7. EXTERIOR GAS PIPING SHALL BE PROVIDED WITH A PROTECTIVE
COATING, SUCH AS PAINT, TO PREVENT CORROSION.
8. GAS LINES RUN IN CONCEALED LOCATIONS SHALL BE LIMITED TO
THE FOLLOWING FITTINGS. THEREADE DE LBOWS, TEES, COUPLINGS,
BRAZED, WELDED, AND FITTINGS LISTED TO ANSILC-JCSA 6.26 OR
ANSILC-4.


BRAZED, WELDED, AND FITTINGS LISTED TO MIST CANDED AND AND ALL GAS PIPING FROM PHYSICAL DAMAGE IN CONCEALED AREAS BY THE USE OF SHIELDED PLATES.


10. ALL NEW GAS PIPING SHALL BE TESTED IN ACCORDANCE WITH SECTION, AGO OF THE IFOC. THE SYSTEM SHALL BE PURGED, VISUALLY AND PRESSURE TESTED. SOAP TESTING IS NOT ACCEPTABLE MECHANICAL GAUGES USED TO MEASURE TEST PRESSURES, SHALL HAVE A RANGE SUCH THAT THE HIGHEST END OF THE SCALE IS NOT GREATER THAN 5 TIMES THE TEST PRESSURE. THE TEST SHALL BE WITNESSED AND REPORT PROVIDED.

				ILATION S	OFFE						
AREA DISCRIPTION	ROOM			CHANICAL VENTILA L MECH. CODE TAI				ACTUAL VENTILATION	ACTUAL RETURN	ACTUAL OSA (CFM)	ACTUAL EXHAUST (CFM)
ELCALONIA NA NAVONA CARA	NO.	AREA SQFT	P/1000 SQFT Pz	OSA (CFW) PER PERSON Rp	OUTDOOR AIR RATE Ro	REQUIRED OSA (CFM)	REQUIRED EXHAUST	(CFM)	(CFM)	(3)	
PICK UP/RETAIL	100/101	546	5	5	.06	46	-	750	750	150	-
KITCHEN	102	1013	20	7.5	.12	272	709	800	800	275	SEE HOOD DWG
CLEAN/DRYGOOD	105/106	646	20	7.5	.12	174	452	800	800	275	SEE HOOD DWG
UNISEX	103	48	-	-	-	7 ± 5	-	50	-	100	75
STORAGE	104	25	-	-	*	100	- 1	25	25	1 -	-

			FAN S	CHEDI	JLE @ RE	STROOMS	5		
LABEL	MANUF.	MODEL	CFM	S.P.	MOUNTING	MOTOR HP	RPM	VOLTAGE	WEIGH
CEF-1.	BROAN	L100	75	.25	IN-LINE	2.1 AMPS	759	115V.	25

		MILLES N	EGISTERS	AND DIFF	USERS SCHEDULE
TAG	TYPE	MANUF.	SIZE	DILET SIZE	REMARKS
A	24"X24" SAD	1.00	24"X24"	SEE PLAN	CEILING SUPPLY AIR DIFFUSER-PERFORATED
B	BX10 SAD	1.5%	8X10	SEE PLAN	CEILING SUPPLY REGISTER
3	SIDEWALL RAG	2.00	SEE PLAN	SEE PLAN	RETURN GRILLE

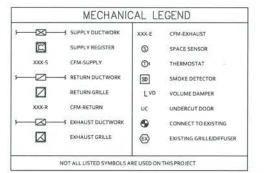

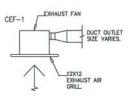

CEILING IN-LINE EXHAUST FAN DETAIL.

					H	EATI	NG /	C00	LING	ROOF	TOP U	INIT SCHE	DULE			
								COOLING		HEA	TING					
3	AREA SERVED	MANUF.	MODEL #	TON	CFM	H.P.	МВН	SEER	EER	INPUT	OUTPUT	VOLTAGE	MCA	MOCP	WEIGHT	NOTES
-1	SPACE	CARRIER	48FCEA07A2A5	6.0	2,400	-	70	14	12	90	88	208-230-3PHS	39	45	607	A DAMPER, ECONOMIZER, EXHAUST DAMPER, PROG STAT

# GENERAL MECHANICAL NOTES

ALL EQUIPMENT SHALL HAVE U.L. LISTING.

ALL GAS FIRED EQUIPMENT SHALL BE "AMERICAN GAS ASSSOCIATION"

ALL INTAKE OPENINGS SHALL BE AT LEAST 10'-0" FROM THE DISCHARGE OUTLET OF ANY EXHAUST FAN. AIR SUPPLY WILL BE UNCONTAMINATED AND OPEINGS WILL BE UNCOSTRUCTED AT ALL TIMES.

SMOKE DETECTORS SHALL BE INSTALLED IN THE RETURN DUCT OF EACH AIR HANDLING SYSTEM OF 2000 CFM OR GREATER TO DETECT AND SHUT DOWN I AIR DISTRIBUTION SYSTEM UPON DETECTION OF SMOKE IN ACCORDANCE WITH

ALL DISCONNECT SWITCHED NOT INCLUDED IN PACKAGED EQUIPMENT SHALL BE APPROVED BY THE ELECTRICAL CONTRACTOR UNLESS OTHERWISE NOTED IN THE EQUIPMENT SCHEDULE STARFERS FOR 3-PHASE MOTORS SHALL BE FURNISHED BY THE ELECTRICAL CONTRACTOR.

REMOTE TEST STATIONS FOR THE DUCT MOUNTED SMOKE DETECTORS (IF REQUIRED) SHALL BE FURNISHED ONLY BY THE ALARM CONTRACTOR FOR THE INSTALLATION AND MIRRIES BY THE JOB ELECTRICAL CONTRACTOR.

THE TEMPERATURE CONTROLS SUBCONTRACTOR SHALL TYPICALLY PULL 24 VOLT POWER FROM THE RESPECTIVE ROOF TOP UNIT FOR THE DUCT MOUNTED SHOWE DETECTOR WHEN NO OTHER TYPE OF FIRE ALARM AND RIRE/SMOKE DETECTION IS INTERCONNECTED WITH THIS DETECTOR AND ITS OPERATION. HOWEVER, IF ANY OTHER TYPE OF DETECTION OR INTERLOCK WITH OTHER RIPE ALARMS SYSTEMS IS REQUIRED THE 24 VOLT POWER FROM THE ROOF TOP UNIT CANNOT BE USED AND THE JOB STE ELECTRICAL CONTRACTOR SHALL HAVE THE RESPONSIBILITY OF PROVIDING AND WRITNE POWER (24 V OR 120 V) TO EACH SMOKE DETECTOR WAS AN APPOPERATE DESIGNATED CIRCUIT. FINAL COORDINATION AND RESPONSIBILITY SHALL BE BY THE JOB SITE

CONDUIT FOR LOWVOLTAGE AND ALARM WIRING BY ELECTRICIAN

ELECTRIC HEATING UNITS (Io. WALL HEATERS, UNIT HEATERS & BASEBOARD) WITH INTEGRAL. THERMOSTAT KITS SHALL BE FURNISHED ONLY BY THE MECHANICAL FOR INSTALLATION AND WRING BY THE JOB ELECTRICAL CONTRACTOR.

GAS PIPING SHALL BE SCHEDULED 40 BLACK STEEL PIPE AS-120 WITH STANDARD BLACK MALLEABLE FITTINGS. PIPE SIZING BASED ON GAS DELIVERY OF 2 LBS. PIPING RUN ON THE ROOF SHALL BE SUPPORTED ON TREATED THIBE SUPPORTS. PIPING INSTALLED INSIDE THE BUILDING SHALL BE SUSPENDED FROM THE TOP CHORD OF BAR JUST WITH CLEYIS HANGERS. GAS PRESSURE REGULATORS SHALL BE INSTALLED AT EACH UNIT CONNECTION.

ALL SUPPLY AND RETURN DUCTWORK IS TO BE LOW PRESSURE AND FABRICATED FROM PRIME GRADE GALVANIZED SHEETMETAL IN STRICT ACCORDANCE WITH SMACHA (27%C.) LOW PRESSURE DESIGN.

ALL DUCT SIZING SHALL BE THE RESPONSIBILITY OF THE LICENSED HVAC CONTRACTOR GRILLES AND DIFFUSERS MAYBE CONNECTED WITH 7" MAXIMUM OF APPOROVED FLEXIBLE DUCT WITH 1" THICK INSULATION AND SCUFF RESISTANT VINYL JACKET, UL 181 TYPE AND CODE APPROVED.

ALL SUPPLY AND RETURN SPIN COLLARS SHALL HAVE VOLUME DAMPERS FOR AIR

FLUES FOR THE GAS FIRED EQUIPMENT WITH POWER VENTERS SHALL TERMINATE WITH A WEATHER CAP A MINIMUM OF 2" ABOVE THE ROOF OR A MINIMUM OF 7" ABOVE GRADE IF A SIDEWALL APPLICATION PER NFPA 54.

FLUES FOR THE GAS FIRED EQUIPMENT SHALL BE TYPE "B-VENT"

IN GENERAL, SHEETMETAL ELBOWS SHALL BE FABRICATED WITH A CENTERLINE RADIUS EQUAL TO 1.0 TIMES THE WIDTH OF THE DUCT IN THE PLANE OF THE TURN. WHERE SPACE DOES NOT PERMIT A RADIUS ELBOWO OUR DESIGN SHALL REVIEW AND SUGGETS SYSTEM COMPATIBLE OPTIONS, SUCH AS ELBOWS

ALL DUCTWORK JOINTS, BOTH LONGITUDINAL AND TRANSVERSE TO BE SEALED WITH DUCTMATE JOINT SEALER AND IN ACCORDANCE WITH THE INTERNATIONAL ENERGY CONSERVATION CODE.
THIS INCLIDES ALL S AND DRIVES AS WELL AS PITTSBURGH, SNAP—LOCK JOINTS, STARTING COLLARS AND ELBOW GORES. 60.39 2015IMC & 503.2.7.1 2015 IECC WITH START AND START AN

DUCTS SHALL BE SUPPORTED WITH APPROVED HANGERS AT INTERVALS NOT TO EXCEED 10FT

CREASE DUCT SHALL BE 16GA BLACK IRON OR 430 18 CALIGE STAINLESS STEEL 100% CONSTRUCTION FACTORY MOUNTED EXHAUST COLLARS FIRE WRAP WITH 3M 3HR BARRIER, HANGER SPACING PER SMACNA

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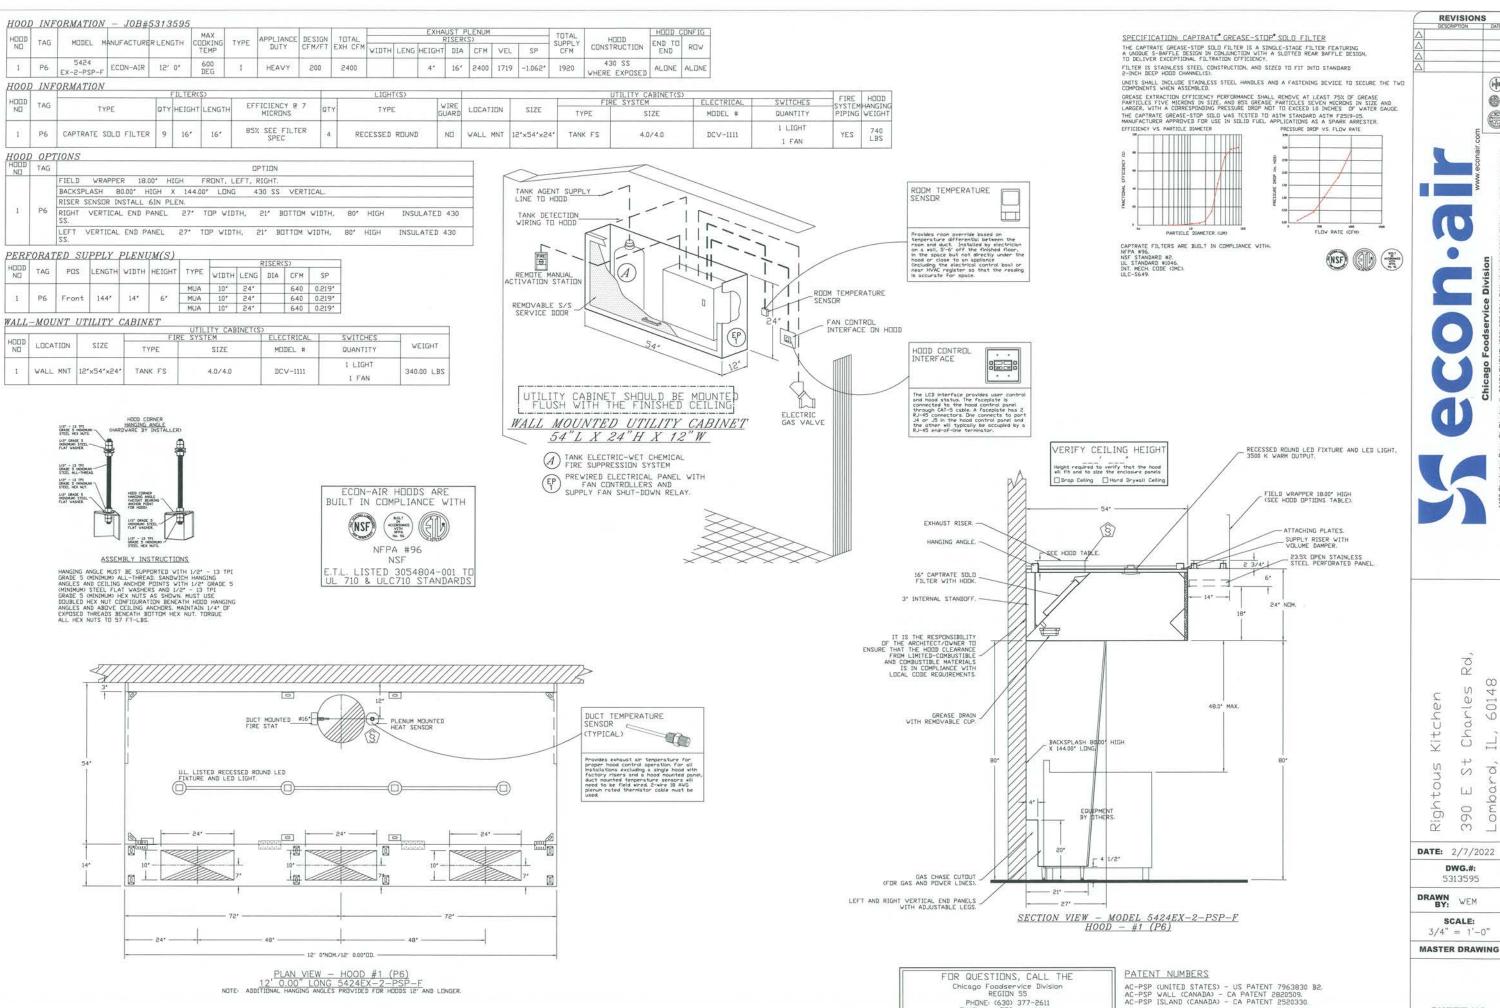


OAKBROOK TERRACE IL 60181 PHONE: 708-508-7281 2.5.22 SCALE:



SHEET NUMBER:

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SHEET NO.

RQ,

Charles

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390 OM

5313595

SCALE: 3/4" = 1'-0"

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REVISIONS


FIRE SYSTEM INFORMATION - JOB#5313595 FIRE SYSTEM TAG INSTALLATION FLOW POINTS TYPE SIZE LOCATION ON HOOD 4.0/4.0 TANK ES WALL UTILITY CABINET LEFT


FIRE SYSTEM	TAG	TYPE	SIZE	SUPPLIED BY
1	FS-1	SC ELECTRICAL	1.500	ECON-AIR


REMOTE MANUAL ACTUATION DEVICE.

							GA	S VALV	ES AND	STRAI	NERS						
		T3 - 15		GA	S VALVE SIZ	NG .			GA	S VALVE	DIMENSI	INS		INSTALLATION		PART NUMBERS	
	TYPE	SIZE	VOLTAGE	MIN. INLET PRESSURE	MAX. INLET PRESSURE	FLOW AT 1 IN.W.C. DROP NATURAL GAS	FLOW AT 1 IN W.C. DROP PROPANE	DIM "A"	DIM "B"	DIM "C"	DIM "D"	DIM "F"	DIM "G"	MOUNTING ORIENTATION	GAS VALVE PART NUMBER	STRAINER PART NUMBER	GAS VALVE/STRAINER K
AS VALVE FOR FS#1-	ELECTRICAL	1-1/2	120 VAC	0 PSI (0 IN.W.C.)	5 PSI (138 N.W.C.)	2,406,000 BTU/HR	1,561,219 BTU/HR	7-5/8"	6-3/8*	5-3/4"	6-3/16*	14-1/8*	12-5/16"	HORIZONTAL/ VERTICAL	8214275	4417K67	(SC)EGVA1-1/2

TO CALCULATE GAS FLOW FOR OTHER THAN 1 IN.W.C. PRESSURE DROP
NEW BTL/MR = (BTL/MR AT 1 IN.W.C. PRESSURE DROP) X NEW PRESSURE DROPAS
TO CALCULATE GAS FLOW FOR OTHER THAN QAS SPECIFIC GRAVITY
NEW BTL/MR = (BTL/MR AT C&4) X (O&4 / NEW SPECIFIC GRAVITY)<sup>63</sup>.

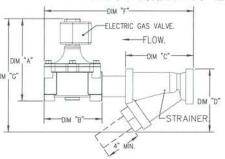

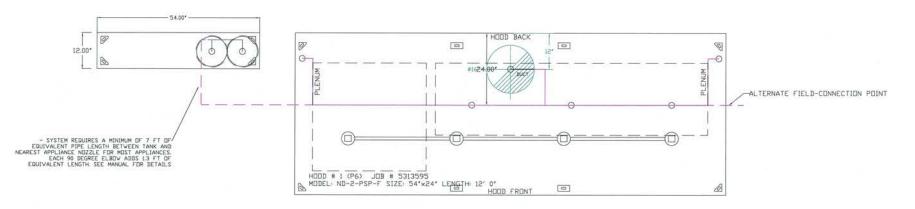

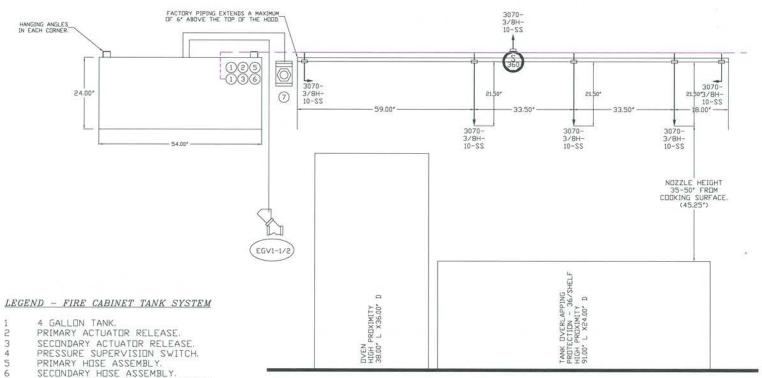

JOB #: 5313595. JOB NAME: RIGHTOUS KITCHEN.

SYSTEM SIZE: TANK-SP-2-WC TOTAL FP REQUIRED: 27. HODD # 1 12' 0.00' LONG x 54' WIDE x 24' HIGH. RISER # 1 SIZE: 16' DIA. HODD # 1 METAL BLOW-OFF CAPS INCLUDED.

- HEAVY-DUTY APPLIANCES (RATED 600°F) WILL REQUIRE AN ADDITIONAL DOWNSTREAM FIRESTAT IN THE EVENT THAT THE DUCTWORK CONTAINS ANY HORIZONTAL RUNS OVER 25 FT IN LENGTH.

- MEDIUM TO LIGHT-DUTY APPLIANCES (RATED 450°F) WILL NOT REQUIRE ANY ADDITIONAL DOWNSTREAM DETECTION.

NOTES
- FIELD PIPE DROPS AS SHOWN
PIPING, ELBOWS, TEES, AND NOZZLES SUPPLIED BY CAS.
- RELOCATE NOZZLES IF FLOW PATTERN IS BLOCKED BY SHELVING,
SALAMANDERS, ETC.
- DVERLAPPING COVERAGE SHALL NOT BE USED ON ANY APPLIANCE WITH AN OBSTRUCTION.
- IF APPLICABLE, EXTENDED PRE-PIPED DROPS ARE SHIPPED LODSE.
- FACTORY PIPING EXTENDS A MAXIMUM OF 6' ABOVE THE TOP OF THE HOOD.

- APPLIANCE DIMENSIONS LISTED REPRESENT THE COOKING SURFACE SIZE, NOT THE OVERALL APPLIANCE SIZE.

- THIS FIRE SYSTEM COMPLIES WITH U.L. 300 REQUIREMENTS.

Ra, 60148 Charles Kitchen Rightous ठ S QQ ليا 390 Lom

DATE: 2/7/2022

DWG.#:

5313595

DRAWN BY: WEM

SCALE: 3/4" = 1'-0"

MASTER DRAWING

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	4UST	FAN	INFORMATION - JOB#5	313595		W-										
FAN UNIT NO	TAG	QTY	FAN UNIT MODEL #	MANUFACTURER	CFM	ESP	RPM	MOTOR ENCL	HP	BHP	PHASE	VOLT	FLA	DISCHARGE VELDCITY	WEIGHT (LBS)	SONE
1	EF-I	1	EADU180H	ECON-AIR	2400	1.250	1147	DDP,PREMIUM	2.000	1.0370	3	508	6.1	554 FPM	163	14.2

MUA FAN INFORMATION - JOB#5313595

FAN UNIT NO	TAG	QTY	FAN UNIT MODEL #	BLOWER	HOUSING	MIN CFM	DESIGN CFM	ESP	RPM	MOTOR ENCL	HP	BHP	PHASE	VOLT	FLA	MCA	маср	WEIGHT (LBS)	SONES
2	MUA-1	1	EA1-D.250-15D	15MF-1-MOD	A1-D.250	1000	1920	0.375	1963	ODP,PREMIUM	3.000	1.1760	3	208	8.6	10.8A	15A	501	19.8

GAS FIRED MAKE-UP AIR UNIT(S)

FAN UNIT NO	TAG	INPUT BTUs	DUTPUT BTUs	TEMP RISE	REQUIRED INPUT GAS PRESSURE	GAS TYPE	BURNER EFFICIENCY(%)
5	MUA-1	171473	157755	80°F	7 IN. W.C 14 IN. W.C.	NATURAL	92

FAN OPTIONS

ZIZY.	VI IIV	YU								
FAN UNIT NO	TAG	QTY	DESCRIPTION							
	EF-1	1	GREASE BOX							
1		1	FAN BASE CERAMIC SEAL - SHIP LOUSE - FOR GREASE DUCTS							
		1	2 YEAR PARTS WARRANTY							
	MUA-1	1	INLET PRESSURE GAUGE, 0-35'							
S		1	MANIFOLD PRESSURE GAUGE, -5 TO 15' WC							
		1	LOW FIRE START							
		1	AC INTERLUCK RELAY - 24VAC CUIL							
		1	MOTORIZED BACKDRAFT DAMPER FOR AI-D HOUSING - MEETS AMCA CLASS IA RATING							
		1	SEPARATE 120V WIRING PACKAGE (REQUIRED AND USED ONLY FOR DCV OR PREWIRE WITH VFD) - THREE PHASE ONLY							
	İ	1	2 YEAR PARTS WARRANTY							


FAN ACCESSORIES


FAN	***		EXHAUST		SUPF	PLY	
ND	TAG	GREASE CUP	GRAVITY DAMPER	SIDE DISCHARGE		MOTORIZED DAMPER	WALL
1	EF-1	YES					
5	MUA-1					YES	

CURB ASSEMBLIES

NO	FAN	TAG	WEIGHT	ITEM	SIZE
1	# 1	EF-1	38 LBS	CURB	26.500°W X 26.500°L X 24.000°H ALDNG LENGTH, RIGHT VENTED HINGED.
2	# 2	MUA-1	65 LBS	CURB	21.000'W X 71.000'L X 20.000'H ALDNG WIDTH, RIGHT INSULATED.

### FAN #1 EADU180H - EXHAUST FAN (EF-1)

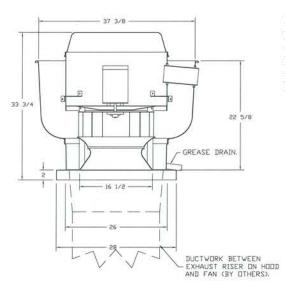

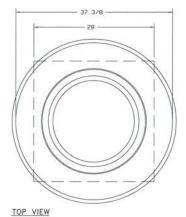

# FEATURES:

- DIRECT DRIVE CONSTRUCTION (NO BELTS/PULLEYS).

  RODF MOUNTED FANS.

  RESTAURANT MODEL.

  UL705 AND UL762 AND ULC-S645

  VARIABLE SPEED CONTROL.

  INTERNAL VIRING.

  THERMAL OVERLOAD PROTECTION (SINGLE PHASE).

  HIGH HEAT DERARTION 300°F (149°C).


  GREASE CLASSIFICATION TESTING.

  NEMA 3R SAFETY DISCONNECT SVITCH.


NORMAL TEMPERATURE TEST
EXHAUST FAN MUST DPERATE CONTINUOUSLY
VHILE EXHAUSTING AIR AT 300°F (149°C)
UNTIL ALL FAN PARTS HAVE REACHED
THERMAL EQUILIBRIUM, AND VITHOUT ANY
DETERLIBRATING EFFECTS TO THE FAN WHICH
WOULD CAUSE UNSAFE OPERATION.

ABNORMAL FLARE-UP TEST
EXHAUST FAN MUST DPERATE CONTINUOUSLY
VHILE EXHAUSTING BURNING GREASE VAPORS
AT 600°F C316°C) FOR A PERIDD OF
15 MINUTES VITHOUT THE FAN BECOMING
DAMAGED TO ANY EXTENT THAT COULD CAUSE
AN UNSAFE CONDITION.

DPTIONS GREASE BOX. FAN BASE CERAMIC SEAL - SHIP LOOSE -FOR GREASE DUCTS. 2 YEAR PARTS WARRANTY.

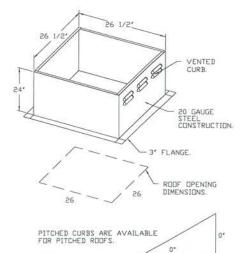

SPECIFY PITCH: EXAMPLE: 7/12 PITCH = 30° SLOPE.

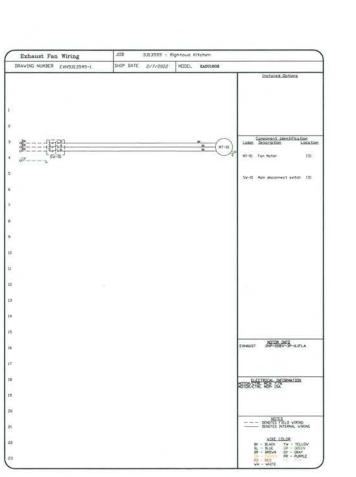



REVISIONS

RQ, 60148 Charles Kitchen Rightous St 0 Lombar ليا 390

DATE: 2/7/2022 DWG.#:

5313595 DRAWN BY: WEM

> SCALE: 3/4" = 1'-0"

MASTER DRAWING

SHEET NO.

FAN BE CAI-D250-ISD - HEATER (MUA-I)

1. DIRECT CAS FIRED HEATER MAKE UP AIR UNIT WITH IS' MIXED FLOW DIRECT DRIVE FAN.

2. INTAKE HODD WITH EZ FILTERS.

3. DOWN DISCHARGE - AIR FLOW RIGHT -> LEFT.

4. GAS PRESSURE GAUGE, 0-35°, 25° DIAMETER, 1/4' THREAD SIZE.

5. GAS PRESSURE GAUGE, 0-55°, 25° DIAMETER, 1/4' THREAD SIZE.

6. LOW FIRE START. ALLOWS THE BURNER CIRCUIT TO EMERGIZE WHEN THE MODULATION CONTROL IS IN A LOW FIRE POSITION.

7. CODLING INTERLOCK RELAY. 24VAC COIL. 120V CONTACTS. LOCKS DUT BURNER CIRCUIT WHEN AC IS EMERGIZED.

8. MOTINIZED BACK BRATT DAMER 16' X 18° FOR SIZE I STANDARD 8 MODULAR HEATER UNITS WYEXTENDED SHAFT, STANDARD

6. STANDARD CONTROLLED SHACK BRATT DAMER 16' X 18° FOR SIZE I STANDARD 8 MODULAR HEATER UNITS WYEXTENDED SHAFT, STANDARD

6. STANDARD CONTROLLED SHACK BRATT DAMER 16' X 18° FOR SIZE I STANDARD 8 MODULAR HEATER UNITS WYEXTENDED SHAFT, STANDARD

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6. STANDARD SHACK BRATT DAMER 16' X 18° FOR SIZE I STANDARD 8 MODULAR HEATER WITH SWITS WYEXTENDED SHAFT, STANDARD

6. STANDARD SHACK BRATT DAMER 16' X 18° FOR SIZE I STANDARD 8 MODULAR HEATER WITH SWITS WYEXTENDED SHAFT, STANDARD

6. STANDARD SHACK BRATT DAMER 16' X 18° FOR SIZE I STANDARD 8 MODULAR HEATER WOUNTING VFD IN PREVIEW SIZE IS STANDARD 8 MODULAR WALL INSULATED SHAFT, STANDARD 8 MODULAR WALL INSULATED DOOR ASSEMBLY (BURNER/BLOVER SECTION).


11. 2 YEAR PARTS WARRANTY


\*\*NDTE: SUPPLY DUCT MUST BE INSTALLED TO MEET SMACNA STANDARDS. A MINIMUM STRAIGHT DUCT LENGTH MUST BE MAINTAINED DOWNSTREAM OF UNIT DISCHARGE AS GUTLINED IN AMCA PUBLICATION 201. WHEN USING RECTANGULAR DUCTVORK, ELBOWS MUST BE RADIUS THROAT, RADIUS BACK WITH TURNING VANES, FLEXIBLE DUCTVORK AND SQUARE THROAT/SQUARE BACK ELBOWS SHOULD NOT BE USED. ANY TRANSITION AND/OR TURNS IN THE DUCTVORK WILL CAUSE SYSTEM EFFECT VILL. BRASTICALLY INCREASE STATIC PRESSURE AND REDUCE AIRFLOW. BO NOT RELY ON UNIT TO SUPPORT DUCT IN ANY WAY. FAILURE TO PROPERLY SIZE DUCTVORK MAY CAUSE SYSTEM EFFECTS AND REDUCE PERFORMANCE OF THE EQUIPMENT. SUGGESTED STRAIGHT DUCT SIZE IS 14" × 14".


#### SUPPLY SIDE HEATER INFORMATION

VINTER TEMPERATURE = 2°F. TEMP. RISE = 80°F. BTUS CALCULATED OFF ACTUAL AIR DENSITY. CUTPUT BTUS AT ALTITUDE OF 00 FT. = 161976. INPUT BTUS AT ALTITUDE OF 00 FT. = 176061. DUTPUT BTUS AT ALTITUDE OF 729 FT. = 157755. INPUT BTUS AT ALTITUDE OF 729 FT. = 171472.



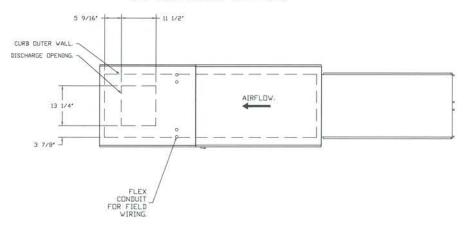

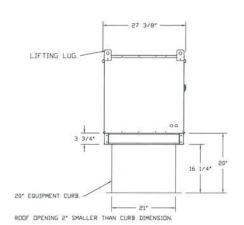

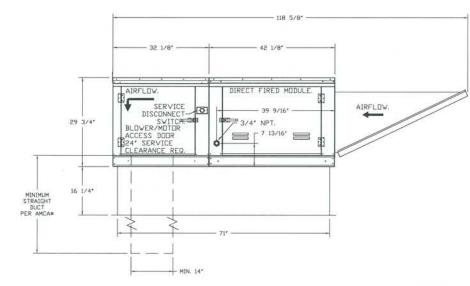



DIRECT FIRED (DF) PROFILE PLATE ASSEMBLY

BIRCT FIRED PROFILE PLAIL SPECIFICATIONS

EXSERPTION

BIRCT FIRED BIRMERS SHALL HAVE PATENTED OUS PATENT NO. US6627523827, ZCLF-ADJUSTING PROFILE

FLAIGS DESIGNED TO DESIDE PROFILE AN VELOCITY AND PRESSURE DROW ACCOSS THE BURNER PROFILE

FLAIR DESIGNED TO DESIDE PROFILE AND APPLIED TO THE STREET FOR THE STREET PROFILE

MARIAN OF SPH DE CARRON MORNIDE COD. AND OSPIP OF INTEROSED IDUNIES OCCUPIENT FIRED TO

MARIAN OF SPH DE CARRON MORNIDE COD. AND OSPIP OF INTEROSED IDUNIES OCCUPIENT FIRED TO

MILL SHORE A CONSISTENT ARTON, RECORDED SO THAT ARE THE SURFAILED.


CERTIFICATIONS
ALL PROFILE PLATE ASSENDEDS SHALL BE INCLUDED IN THE DF UNIT'S ETL LISTING AND COMPLY WITH COMBINED SAFETY STRANDARDS ANSI 2834 AND CSA 3.7 ONDH-RECIRCULATING DF HEATERS) AND ANSI 28318 ORDERCULATING DF MEATERS).


GENERAL CONSTRUCTION.

BE FORMED FROM 090 GAL VANIZED STEEL.

-PROFILE PLATES SHALL BE FORMED FROM 090 GAL VANIZED STEEL.

-PROFILE PLATES SHALL BE MOUNTED ALTON TO THE SAME PLANE AS THE DISCHARGE OF THE BURNER.
-DESIGN SHALL INCORPORATE PROPERTY TOROUGH, PERHAMENTLY MOUNTED SPRING HINGES.
-PERION SHALLS SHALL BE MOUNTED ALTON TO THE SAME PLANE AS THE DISCHARGE OF THE BURNER.
-PERION SHALLS SHALL BE MOUNTED ALTON TO THE SAME PLANE AS THE DISCHARGE OF THE BURNER.

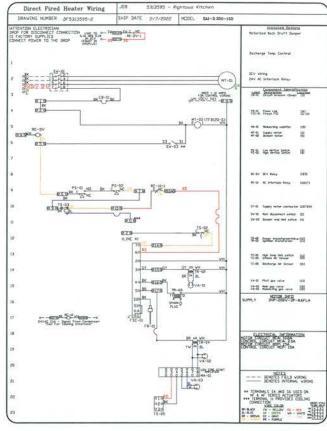

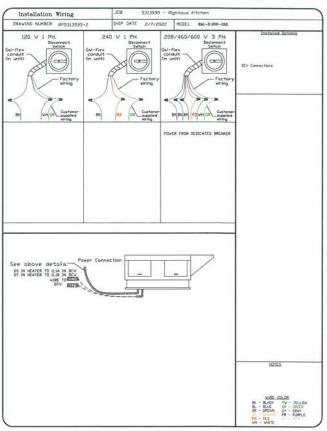



REVISIONS

Rd, 60148 Charles Kitchen tous ठ 0 Lombar لنا Righ. 390

DATE: 2/7/2022 DWG.#:


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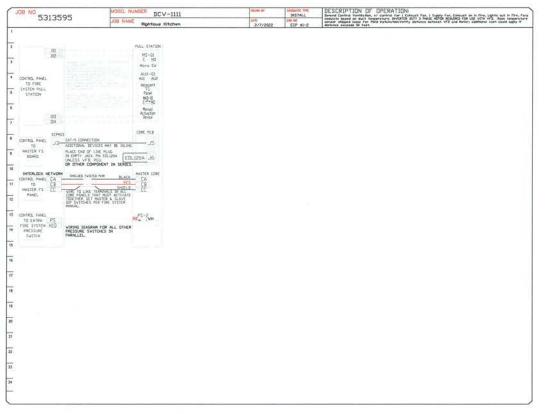
> SCALE: 3/4" = 1'-0"


MASTER DRAWING


SHEET NO.

40	TAG	PACKAGE W	LOCATION	SWITCHE	2:	OPTION	FANS CONTROLLED						
1			7707(((000)))	LOCATION	QUANTITY	ASSAULT AND A	FAN TAG	TYPE		HP	VOLT	FLA	
	ECP-1	DCV-1111	WALL UTILITY CABINET LEFT	OI - FACE MOUNT LEFT SIDE OF HODD	1 LIGHT	CHART CONTON C BOLL	EF-1	EXHAUST	3	2.000	208	6.1	
*	CCF-1	ne v-iiii	WALL GITTIT CABINET LEFT	HOOD # 1	1 FAN	SMART CONTROLS DCV	MUA-1	SUPPLY	3	3.000	208	8.6	



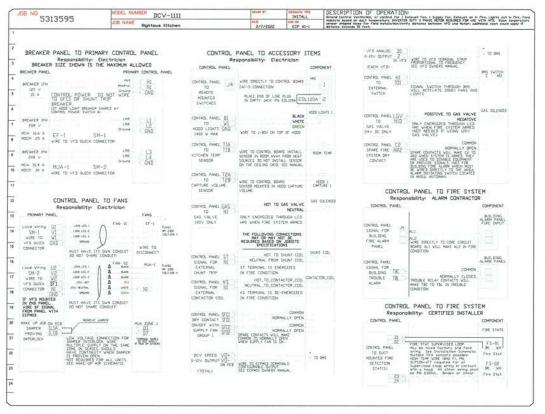

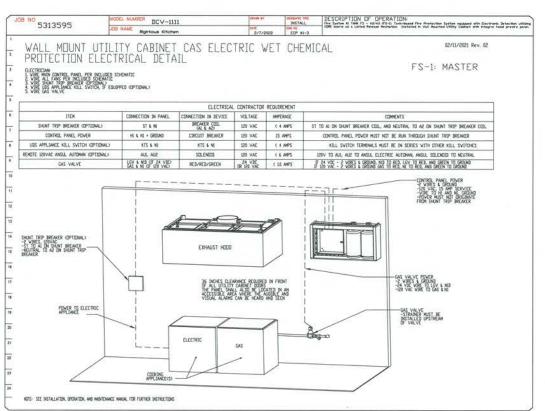

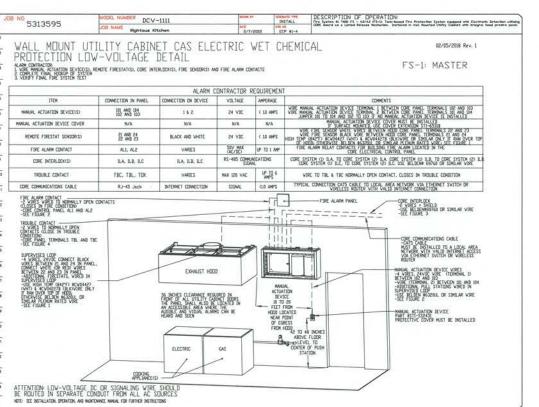



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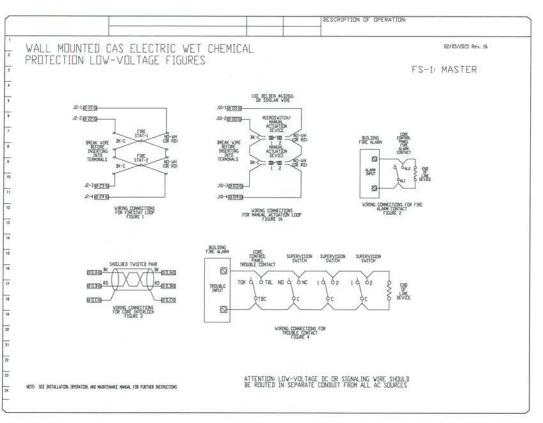
**DWG.#:** 5313595


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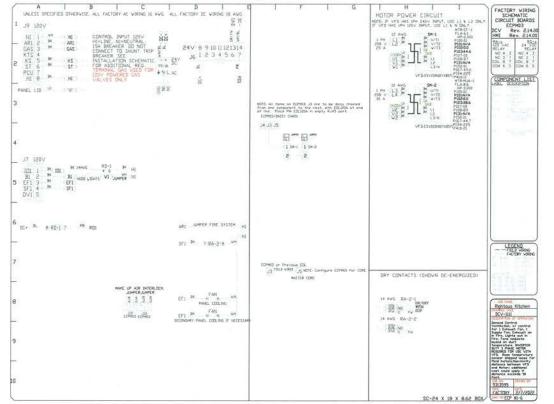
**SCALE:** 3/4" = 1'-0"

MASTER DRAWING

SHEET NO.





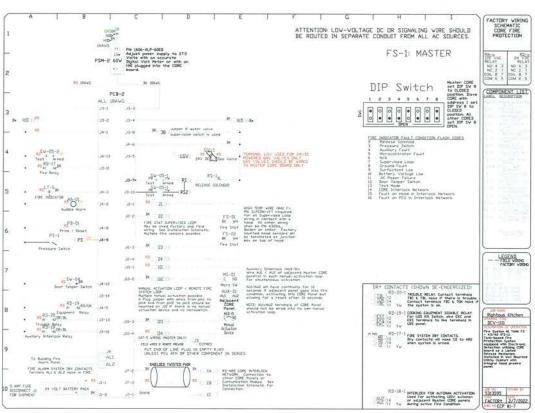

DEMAND CONTROL VENTILATION HODD CONTROL PANEL SPECIFICATIONS:

- CONTROLS SHALL BE LISTED BY ETL (UL 300A) AND SHALL COMPLY VITH DEMAND VENTILATION SYSTEM TURNDOWN REQUIREMENTS DUTLINGD IN IECC 403.28 e2015.

THE CONTROL ENCLOSURE SHALL BE NEMA 1 RATED AND LISTED FOR INSTALLATION INSIDE OF THE EXHAUST HODD UTILITY CABINET. THE CONTROL ENCLOSURE MAY BE CONSTRUCTED OF STAINLESS STEEL OR PAINTED STEEL.

- TEMPERATURE PROBE(S) LOCATED IN THE EXHAUST DUCT RISER(S) SHALL BE CONSTRUCTED OF STAINLESS STEEL.
- A DIGITAL CONTROLLER SHALL BE PROVIDED TO ACTIVATE THE HODD EXHAUST FANS DYNAMICALLY BASED ON A FIXED DIFFERENTIAL BETVEEN THE AMBIENT AND DUCT TEMPERATURES SENSORS. THIS FUNCTION SHALL MEET THE REQUIREMENTS OF IMM, SO7.11.
- A DIGITAL CONTROLLER SHALL PROVIDE ADJUSTABLE HYSTERESIS SETTINGS TO PREVENT CYCLING OF THE FANS AFTER THE CODKING APPLIANCES HAVE BEEN TURNED OFF AND/OR THE HEAT IN THE EXHAUST SYSTEM IS REDUCED.
- A DIGITAL CONTROLLER SHALL PROVIDE AN ADJUSTABLE MINIMUM FAN RUN-TIME SETTING TO PREVENT FAN CYCLING.
- VARIABLE FREQUENCY DRIVES (VFDS) SHALL BE PROVIDED FOR FANS AS REQUIRED. THE DIGITAL CONTROLLER SHALL MODULATE THE VFDS BETVEEN A MINIMUM SETPOINT AND A MAXIMUM SETPOINT ON DEMAND. THE DUCT TEMPERATURE SENSIOR INPUT(S) TO THE DIGITAL CONTROLLER SHALL BE USED TO CALCULATE THE SPEED REFERENCE SIGNAL.
- THE VFD SPEED RANGE OF OPERATION SHALL BE FROM OX TO 100X FOR THE SYSTEM, VITH THE ACTUAL MINIMUM SPEED SET AS REQUIRED TO MEET MINIMUM VENTILATION REQUIREMENTS.
- AN INTERNAL ALGORITHM TO THE DIGITAL CONTROLLER SHALL MODULATE SUPPLY FAN VFD SPEED PROPORTIONAL TO ALL EXHAUST FANS THAT ARE LOCATED IN THE SAME FAN GROUP AS THE SUPPLY FAN.
- THE SYSTEM SHALL DPERATE IN PREP MODE DURING LIGHT COOKING LOAD OR COOL DOWN MODE WHEN SUFFICIENT HEAT REMAINS UNDERNEATH THE HOOD SYSTEM AFTER CODKING DEPARTIONS HAVE COMPLETED. DPERATION DURING EITHER OF THESE PERIODS WILL DISABLE THE SUPPLY FANS AND PROVIDE AN EXHAUST FAN SPEED THAT IS EQUAL TO THE MINIMUM VENTLATION REQUIREMENT.
- A DIGITAL CONTROLLER SHALL DISABLE THE SUPPLY FANCS), ACTIVATE THE EXHAUST FANCS, ACTIVATE THE APPLIANCE SHANT TRIP, AND DISABLE AN ELECTRIC GAS VALVE AUTOMATICALLY WHEN FIRE CONDITION DESCRIPTION A COVERED HOUSE.
- AN LCD INTERFACE SHALL BE PROVIDED WITH THE FOLLOWING FEATURES.

  A DA/DEF PUSH BUTTON FAN & LIGHT SWITCH ACTIVATION.

  INTEGRATED GAS VALVE RESET FOR ELECTRONIC GAS VALVES (ND RESET RELAY REQUIRED).


  OF FAULT DISPLAY WITH AUDIBLE & VISUAL ALARM NOTIFICATION.

  BUCT TEMPERATURE SENSOR FAILURE DETECTION WITH AUDIBLE & VISUAL ALARM NOTIFICATION.

  MIS-WIRED DUCT TEMPERATURE SENSOR DETECTION WITH AUDIBLE & VISUAL ALARM NOTIFICATION.

  A SINGLE LOW VOLTAGE CAT-S RAJS VIRING CONNECTION.

  AN ENERGY SAVINGS INDICATOR THAT UTILIZES MEASURED KWH FROM THE VFDS.

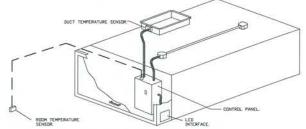

TYPICAL HOOD CONTROL PANEL INSTALLATION

SEQUENCE OF OPERATIONS: THE HOOD CONTROL PANEL IS CAPABLE OF OPERATING IN ONE OR MORE OF THE FOLLOWING STATES AT ANY

IEN TIME:

AUTIMATIC THE SYSTEM DERRATES BASED IN THE DIFFERENTIAL BETWEEN ROUN TEMPERATURE AND THE AUTIMATIC THE SYSTEM DERRATES BASED IN THE DIFFERENTIAL BETWEEN ROUN TEMPERATURE AND THE TEMPERATURE AT THE HOOD CAVITY OR EXHAUST DUCT COLLAR FANS ACTIVATE AT A CONFIGURATION CAVITY OR EXHAUST DUCT COLLAR FANS ACTIVATE AT A CONFIGURATION CAVITY OR EXHAUST DIFFERENTIAL THRESHOLD BEPENDING IN THE JOB CONFIGURATION EACH FAN ZONE CAN BE CONFIGURATION FOR DIVINE MOTHER AS CAVITATION FOR THE PARKE IS EQUIPPED WITH VARIABLE SPEED FANS AND THE ZONE IS DEFINED AS "DYNAMIC", THESE VILL MODULATE WITHIN A USER-DEFINED RANCE BASED ON THE TEMPERATURE DIFFERENTIAL PARKEL SOURPPED WITH VARIABLE SPEED FANS AND A FAN ZONE DEFINED AS "STATIC", FANS WILL RUN AT A SET SPEED CALCULATED FOR THE DIVINE DEFAND CONTROL VENTILATION SYSTEMS ARE CAPABLE OF MODULATING EXHAUST AND MAKE UP AIR FAN SPEEDS PER THE REQUIREMENTS DUTLINED IN IECC 4032-8.

- MANUAL: THE SYSTEM OPERATES BASED ON HUMAN INPUT FROM AN HMI.
- SCHEDULE A VEEKLY SCHEDULE CAN BE SET TO RUN FANS FOR A SPECIFIED PERIOD THROUGHOUT THE DAY. THERE ARE THREE OCCUPIED TIMES PER DAY TO ALLOW FOR THE USER TO SET UP A TIME THAT IS SUITABLE TO THEIR NEEDS ANY TIME THAT IS STITM THE DESTRIBED OCCUPIED TIME, THE SYSTEM WILL R AT MODULATION MODE AND FOLLOW THE FAN PROCEDURE ALGORITHM BASED ON TEMPERATURE DURING THIS TIME. DURING CUNCICUPIED TIME, THE SYSTEM VILL HAVE AN EXTRA DEFSET TO PREVENT UNINTENDED ACTIVATION OF THE SYSTEM DURING A TIME VHERE THE SYSTEM IS NOT BEING DCCUPIED.
- <u>OTHER</u>: THE SYSTEM OPERATES BASED ON THE INPUT FROM AN EXTERNAL SQURCE (DDC, BMS OR HARD-VIRED INTERLOCK).
- EIRE: UPON ACTIVATION OF THE HOOD FIRE SUPPRESSION SYSTEM. THE EXHAUST FAN VILL COME ON OR CONTINUE TO TO RUN, THE HOOD MAKEUP AIR VILL SHOTDOWN, AND A SIGNAL VILL BE SENT FOR ACTIVATING THE SHUTT TRIP BREAKER PROVIDED BY THE ELECTRICIAN FUEL GAS VILL SHUT OFF VIA A MECHANICAL/ELECTRICIA. GAS VALVE ACTUATED BY THE HOOD FIRE SUPPRESSION SYSTEM.

REVISIONS

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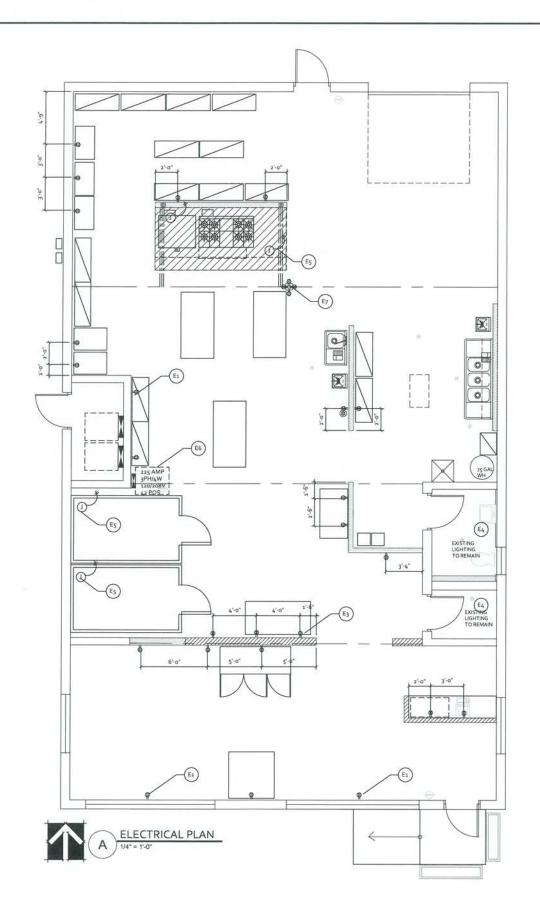
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DRAWN BY: WEM

SCALE: 3/4" = 1'-0"

MASTER DRAWING

SHEET NO.



# LEGEND



EXIT SIGNJEM COMBO UNIT WITH 90 MIN.
BATTERY BACK-UP. MAX 5WATTS PER
SIDE
EXIT SIGN WITH 90 MIN. BATTERY
BACK-UP. MAX 5WATTS PER SIDE

3

EMERGENCY LIGHTING W/ 90 MIN BATTERY BACK-UP

FIRE EXTINGUISHER

Φ DUPLEX OUTLET

# 110V QUAD OUTLET

 $\Phi^{D}$ DEDICATED OUTLET

 $\Phi$ 110V RECESSED FLOOR OUTLET

DATA/PHONE OUTLET PROVIDE 3/4" CONDUIT STUB UP ABOVE CEILING- LOW VOLTAGE INSTALL BY OTHERS.

2'x4' 120V 35W LAY-IN LED LIGHT FIXTURE WITH COVERED LENSES-REPLACE EXISTING FIXTURES WITH NEW. ADJUST LOCATION AS NEEDED


O 6" LED CAN LIGHT 13W

50CFM EXHAUST FAN UNIT

NEW HVAC SUPPLY DIFFUSER



OCCUPANCY SENSOR-VERIFY/PROVIDE AT EXISTING RESTROOM/JAN CLOSET/ STORAGE ROOMS

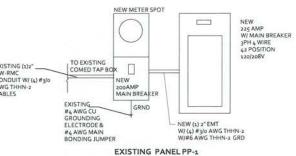

# **ELECTRICAL NOTES:**

LECCI NICAL NOTES:

1. WHERE CIRCUIT CONDUCTORS ARE SPLICED IN A
JUNCTION BOX, ANY ASSOCIATED EQUIPMENT
GROUNDING CONDUCTORS (EGC) SHALL BE BONDED
(PIGTAILED) TO THE BOX. NEC 230-148

2. PROPER CLEARANCES FOR THE ELECTRICAL PANEL.
SHALL BE MAINTAINED PER NEC 130-26

3. AT LEAST (3) 230V 15 OR 20AMP RECEPTACLE SHALL
BE INSTALLED ABOVE THE TOP OF A SHOW WINDOW
AND FOR EACH 12 LINEAR FEET OR MAJOR FRACTION
THEREOP MEASURED HORIZONTALLY AT ITS
MAXIMUM WIDTH. VERIFY AND/OR PROVIDE.

4. TYPE AC, TYPE MC, AND ROMEX ARE PROHIBITED
FROM USE.

# ELECTRICAL NOTES

ELECTRICAL NOTES

EL PROVIDE TYPICAL DUPLEX/QUAD OUTLET, ALL
OUTLETS LOCATED AT EXISTING MASONRY WALLS AND
OR TO EXISTING WALK-IN-COOLER TO BE SURFACE
MOUNTED. TYPICAL OUTLET HEIGHT IS 38" UNLESS
NOTED OTHERWISE.
E. PROVIDE MERCHANDISE OUTLETS AT CEILING LEVEL
ABOVE WINDOWS.
E. PROVIDE POWER AT EQUIPMENT LOCATIONS AS
SHOWN. SHUNT TRIP BREAKER REQUIRED FOR ANY/ALL
ELECTRIC UNDER HOOD. SEE MANUF. SPEC SHEET FOR
INSTALLATION REQUIREMENTS.
E. EXISTING RESTROOM OUTLETS/FAN/LIGHTING TO
REMAIN- NO WORK
E. PROVIDE JUNCTION BOX AT EQUIPMENT LOCATIONS
AS SHOWN.
ES NEW 33 AMP 330/38V ELECTRICAL SERVICE PANEL
E7, COORDINATE WITH CARPENTER FOR PADDED OUT
COLUMN AT THIS LOCATION FOR POWER POLE INSTALL

						PA	NE	LP	P-1								
						SERVI	DE: 12	0/208	V., 3P	H.							
MFR: CUTLER-HAMMER TYPE: NEW BUS: 200 AMP.					N	LO		IN: T		P.MAI	N BREA	KER		MO	UNTING	WEST WALL SURFACE E-1.0	
WALLIES CONTROL	VOLT - AMPS			BREAKER C			CKT. BUS			CKT.	BREA	BREAKER VOL			PS	The state of the s	
BRANCH CIRCUIT	A	В	C	POLE	AMP	NO.	A	В	C	NO.	POLE	AMP	A	В	C	BRANCH CIRCUIT	
RTU-1	2912			2	40	2				2	1	20				0	
RTU-1		2912				3				4	1	20				3	
ROOFTOP GFI			180	2	20	5				6	1	20			285	OUTDOOR SIGNAGE	
HOOD-EXHAUST FAN	900			2	30	7				8	3	100	8400			CONV OVEN	
HOOD-EXHAUST FAN		900				9				10				8400		CONVIOVEN	
HOOD- LIGHTS/AUX			40	10	20	11.				12					8400	CONVOVEN	
HÖLDING CABINET	1440			1	20	.13				14						SHUNT TRIE	
HOLDING CABINET		1440		1	30	15				16						30-0	
KITCHEN LIGHTING			384	1	20	17				18						11100	
PICKUP/AREA LIGHTING	384			1	20	19				20	1	20	1200			AIR COOLER	
GENERAL KITCHEN OUTLETS		1080				21		9		.22						-Ming	
GENERAL KITCHEN OUTLETS/POLE			720	1	30	23				24						Street	
W.I.C DEDICATED	4600			1	20	25				26	1	20	360			WINDOW OUTLETS	
W.I.C DEDICATED		1900		1.	20	27				28	1.	20		360		FRONT COUNTER OUTLETS	
UNISEX OUTLET/FAN			4600	1	20	29				30	1	20			1032	2DR ATOSA FREEZER	
MUA-1	895			2	30	31				32							
MUA-1		895				33				34						5000	
REACH IN FREEZER			1032	1	20	35				36						Shire	
REACH IN FREEZER	1032			1	20	37				38						30,00	
REACH IN FREEZER		1032	_	-1	20	39				40	1	20		480		EMERGENCY LITES/SIGNAGE	
3 DOOR MERCHANDISER			2200			41				42							
VOLT - AMP TOTAL	12163	9079	9156										9960	9240	9717	CONNECTED AMPS	

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ROAD




NE TRANS AM PLAZA DRIVE SUITE #12 OAKBROOK TERRACE IL 60181 PHONE: 708-508-7281

PROJECT ARCHITECT:	DATE:
BG	2-5-22
DRAFTPERSON:	SCALE:
BG STEELER	See Sheet
BG APPROVED : LITTLE SET SET SET SET SET SET SET SET SET SE	COMPUTER NAME
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LOMBARD, IL	OF ILLIAM
LOCATION : 390 E. ST CHARLES BO LOMBARD, IL JOB NUMBER :	EXP:11/30/2

SHEET NUMBER

E-1.0

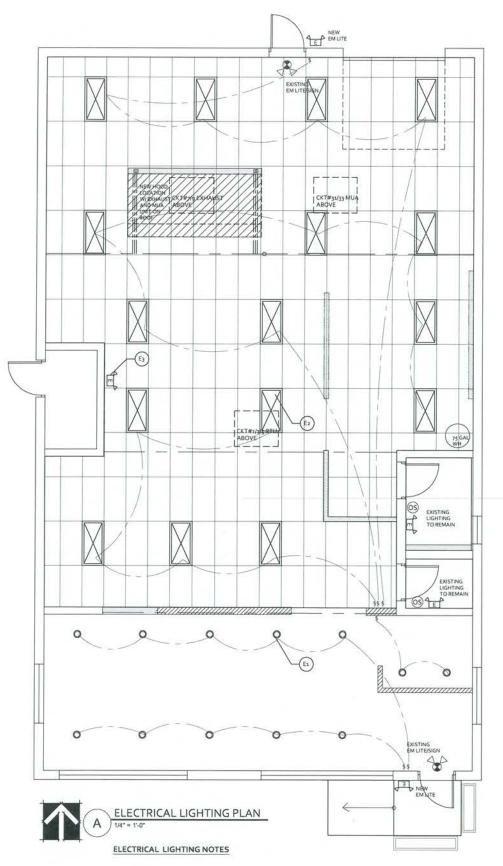

E1. PROVIDE NEW 6" CAN LIGHTING -RETROFIT STYLE SET BETWEEN

EXISTING ROOF JOISTS.

E2. PROVIDE NEW 2X4 LED LIGHTING AT ACCOUSTICAL CEILING LOCATIONS.

LOCATIONS.

E3. PROVIDE NEW EMERGENCY LIGHTING AT LOCATION SHOWN.

EXISTING EM LIGHTING/SIGNAGE AT FRONT AND REAR EXIT TO REMAIN.

# LEGEND



EXIT SIGN/EM COMBO UNIT WITH 90 MIN. BATTERY BACK-UP. MAX 5WATTS PER

EXIT SIGN WITH 90 MIN. BATTERY
BACK-UP. MAX 5WATTS PER SIDE

EMERGENCY LIGHTING W/ 90 MIN BATTERY BACK-UP FIRE EXTINGUISHER

Φ DUPLEX OUTLET

110V QUAD OUTLET

0

DEDICATED OUTLET

110V RECESSED FLOOR OUTLET 

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O 6" LED CAN LIGHT 13W

50CFM EXHAUST FAN UNIT



NEW HVAC SUPPLY DIFFUSER



OCCUPANCY SENSOR-VERIFY/PROVIDE AT EXISTING RESTROOM/JAN CLOSET/ STORAGE ROOMS

# **EMERGENCY LIGHTING** NOTES:

WHERE THERE ARE NO NIGHT LIGHTS. WHERE THERE ARE NO NIGHT LIGHTS, EMERGENCY LIGHTING IS TO BE CONNECTED TO THE NEAREST LIGHTING CIRCUIT SERVING THE NORMAL LIGHTING. IN AREAS OR LOCATIONS WHERE THE LIGHTING IN AREAS OR LOCATIONS UNLESS THE LIGHTING CIRCUIT OR LIGHTS, ARE THE NIGHT LIGHTS, AND THE NIGHT LIGHTS CHITCH EMERGENCY LIGHTS THE SAME AREA AS THE EMERGENCY LIGHTS, THE SAME AREA AS THE EMERGENCY LIGHTS, THE SAME AREA AS THE LIGHT CIRCUIT, CHITCH THE SAME AREA AS THE LIGHT CIRCUIT, THE SAME AREA OF THE NIGHT LIGHT CIRCUIT, REMOTE HEADS ARE NOT ALLOWED.

EXIT SIGNAGE IS TO BE ON ITS OWN INDIVIDUAL BRANCH CIRCUIT

# NOTE TO ELECTRICAL INSPECTOR:

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ELECTRICAL PANEL IS NEW. ELECTRICIAN TO PROVIDE NEW PANEL SCHEDULE AS REQUIRED ON THE PANEL PRIOR TO INSPECTIONS SHOWING ACCURATE LABELING AND VOLT AMPS PER ICRCUIT.

PANEL IS MORE THAN CAPABLE OF HANDLING THE SMALL LOADS REQUIRED FOR THE NEW OUTLET LOCATIONS ADDED TO THE SPECE. ALL WORK TO BE DONE WILL MEET 2017 NATIONAL ELECTRICAL CODE.

EXISTING EM LIGHTING EXISTS AT UNIT, HOWEVER FIXTURES WILL NEED TO BE UPDATED TO MEET CURRENT CODES. INSTALL FIXTURES AS PER APPROVED PLAN LAYOUT ABOVE. PROVIDE EXTERIOR EMERGENCY LIGHTING AT FRONT AND REAR EXIT DOORS.

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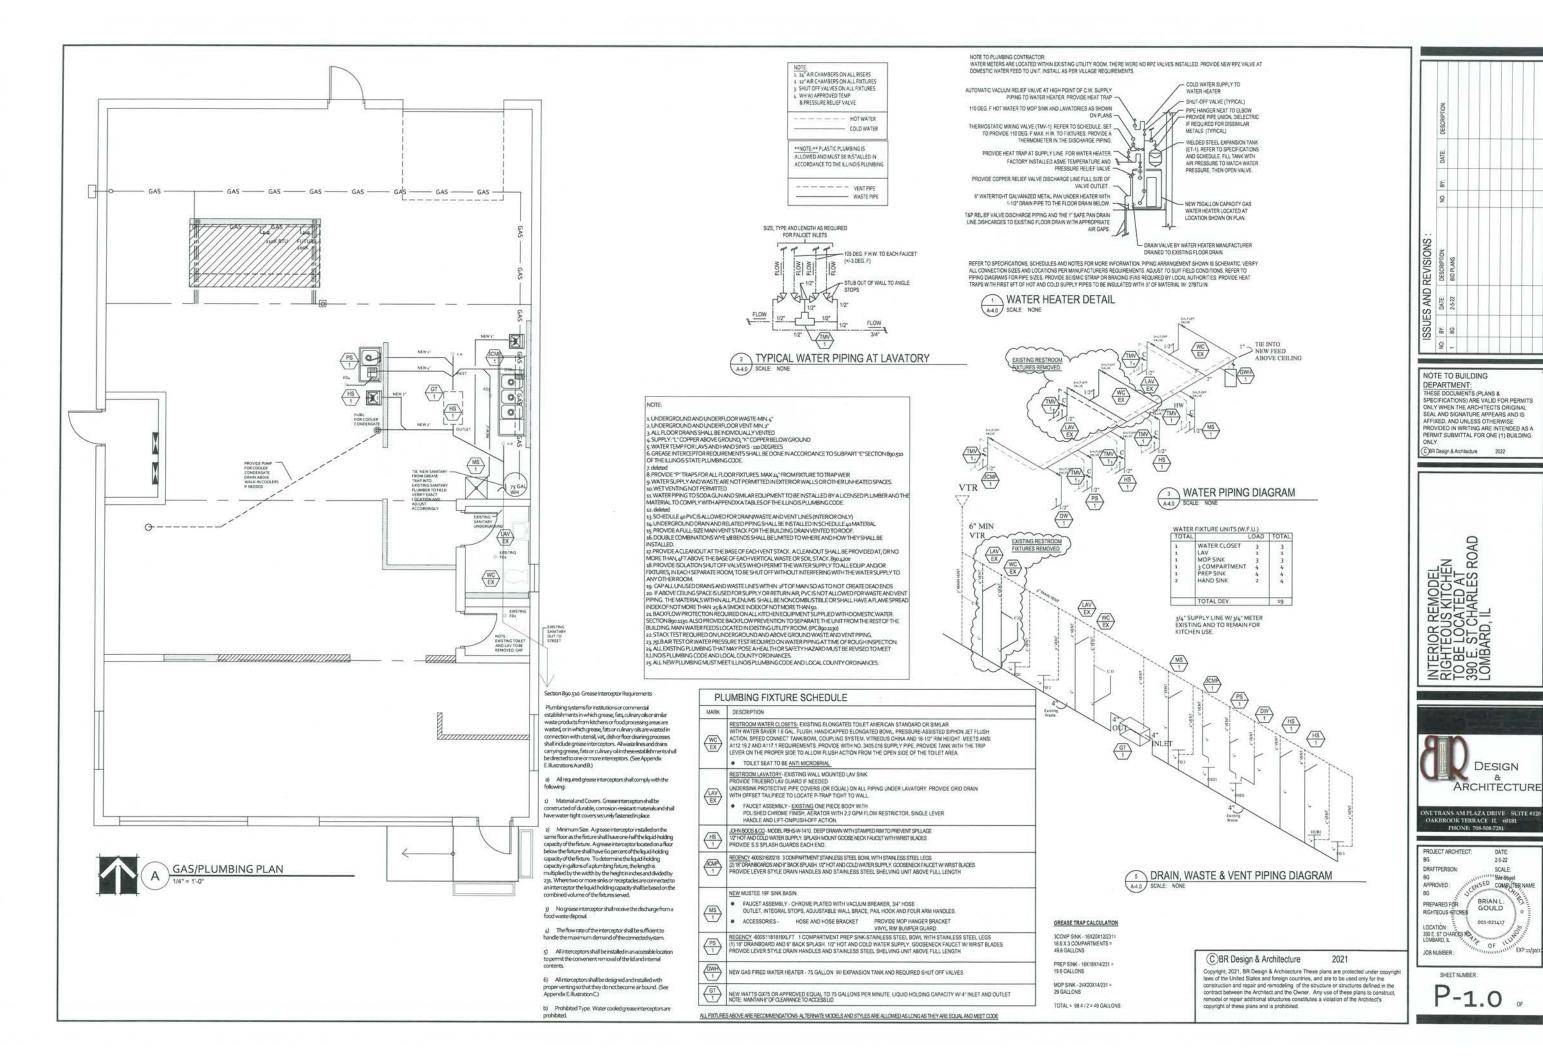
ROAD INTERIOR REMODEL RIGHTEOUS KITCHEN TO BE LOCATED AT 390 E. ST CHARLES RO/ LOMBARD, IL





ONE TRANS AM PLAZA DRIVE SUITE #120 OAKBROOK TERRACE 1L 60181 PHONE: 708-508-7281





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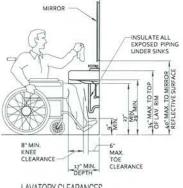




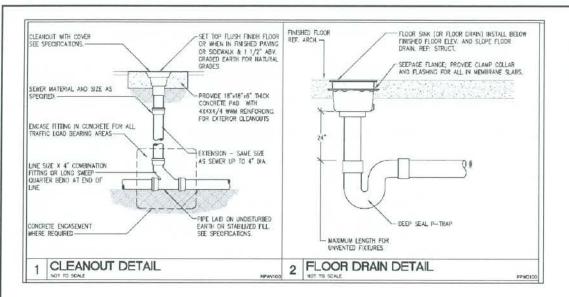

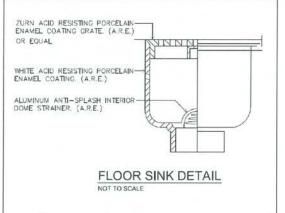

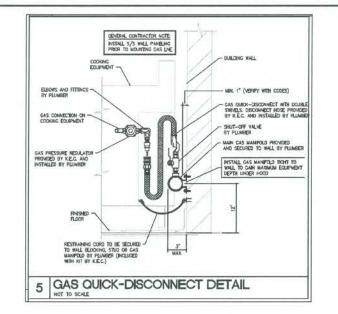

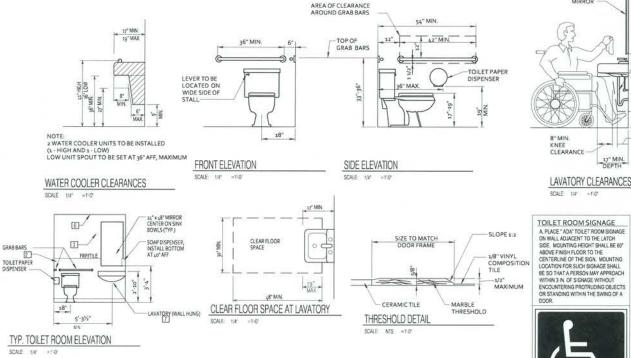

LAVATORY CLEARANCES

A: MIRROR TO BE "BRADLEY OR APPROVED EQUAL TO MEET SPECIFICATIONS

B. GYPSUM BOARD IN TOILET ROOMS TO BE WATER RESISTANT.

TOILET ACCESSORIES

A. GRAB BARS SHALL BE 1:12\*0.D., 18 GAUGE, TYPE 304

STAINLESS STEEL WITH A SATIN FINISH: RAIL SHALL BE DESIGNED FOR WALL TO WALL MOUNTING WITH CONCEALED ANCHORS.

ACCEPTABLE MANUFACTURERS:

BATHROOM SPECIFICATION SPECIFICATIONS

AMERICA SPECIALTIES, INC., BOBRICK, MC KINNEY/PARKER AND BRADLEY CORPORATION. OR APPROVED EQUAL

B. SOAP DISPENSERS, DIAPER DISPENSER, ALUMINUM DOUBLE ROLL PAPER HOLDER FOR EACH WATER CLOSET AND TOWEL HOLDERS, ETC. TO BE SUPPLIED, AND INSTALLED BY GENERAL

C. FOLDED TOWEL DISPENSER SUPPLIED, AND INSTALLED BY SENERAL CONTRACTOR. INSTALLED PER ADA SPECS.



NOTE TO BUILDING NOTE 10 BUILDING
DEPARTMENT:
THESE DOCUMENTS (PLANS &
SPECIFICATIONS) ARE VALID FOR PERMITS
ONLY WHEN THE ARCHITECTS ORIGINAL
SEAL AND SIGNATURE APPEARS AND IS
AFFIXED, AND UNLESS OTHERWISE PROVIDED IN WRITING ARE INTENDED AS A PERMIT SUBMITTAL FOR ONE (1) BUILDING C)BR Design & Architecture

ROAD INTERIOR REMODEL RIGHTEOUS KITCHEN TO BE LOCATED AT 390 E. ST CHARLES RO/ LOMBARD, IL





SHEET NUMBER:

P-1.1

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