

**RESOLUTION
R 70-17**

**A RESOLUTION APPROVING A LICENSE AGREEMENT WITH MOBILITIE,
LLC FOR THE ATTACHMENT OF WIRELESS COMMUNICATION
EQUIPMENT ON A VILLAGE OWNED POLE, AND AUTHORIZING THE
VILLAGE MANAGER TO SIGN SAID LICENSE AGREEMENT ON BEHALF OF
THE VILLAGE, AND TO EXECUTE ANY AND ALL DOCUMENTS, ON
BEHALF OF THE VILLAGE, IN FURTHERANCE OF SAID RESTRUCTURING
SUPPORT LICENSE AGREEMENT AND THE TERMS THEREOF**

BE IT RESOLVED by the President and Board of Trustees of the Village of Lombard, DuPage County, Illinois, that the President and Board of Trustees hereby approve the LICENSE AGREEMENT attached hereto as Exhibit 1 and made part hereof (the "Agreement").

BE IT FURTHER RESOLVED that the Village Manager is hereby authorized and directed to execute the Agreement attached hereto as Exhibit 1, on behalf of the Village, as well as execute any and all additional documents necessary to carry out the terms and provisions of said Agreement.

Adopted this 7th day of December, 2017.

Ayes: Trustee Whittington, Fugiel, Johnston, Pike and Ware

Nays: None

Absent: Trustee Foltyniewicz

Approved this 7th day of December, 2017.


Keith T. Giagnorio
Village President

ATTEST:


Sharon Kuderna
Village Clerk

Exhibit 1

LICENSE AGREEMENT WITH MOBILITIE, LLC

(attached)

LICENSE AGREEMENT

This License Agreement (the "Agreement") made this 7th day of December, 2017 (the "Effective Date"), between the Village of Lombard, an Illinois municipal corporation, with its principal office located at 255 E. Wilson, Lombard, Illinois 60148, hereinafter designated LICENSOR or "Village" and Mobilitie, LLC, a Nevada Limited Liability Company, hereinafter designated LICENSEE. LICENSOR and LICENSEE are at times collectively referred to hereinafter as the "Parties" or individually as the "Party."

WITNESSETH

WHEREAS, LICENSOR is the owner of an existing street light pole on located on or near 22nd Street and S. Main Street in Lombard, Illinois, identified in Exhibit A; and

WHEREAS, LICENSEE desires to install, maintain and operate wireless communications equipment in and/or upon of LICENSOR's existing street light pole, as defined in Exhibit A; and

WHEREAS, LICENSOR and LICENSEE desire to enter into this Agreement to define the terms and conditions which would govern LICENSEE'S ability to install, maintain and operate wireless communications equipment as hereinafter set forth; and

NOW THEREFORE, in consideration of the mutual covenants contained herein and intending to be legally bound hereby, the Parties hereto agree as follows:

1. **PREMISES.** Pursuant to all of the terms and conditions of this Agreement, LICENSOR agrees to license to LICENSEE that certain space on or upon LICENSOR's light pole, hereinafter identified and defined in Exhibit A, and hereinafter referred to as the "Premises", located in the LICENSOR's right-of-way (hereinafter referred to as the "Property") for the installation, operation, repair and maintenance of its wireless communications equipment, including any antenna(s), conduit, fixtures, appurtenances or personal property in relation thereto (hereinafter referred to as the "Equipment" or "Facility"); together with the non-exclusive right of ingress and egress from the Property, seven (7) days a week, twenty-four (24) hours per day to and from the Premises for the purpose of installation, operation, repair and maintenance of LICENSEE'S Equipment. The Parties acknowledge and agree that the Premises is an existing light pole and no new poles or monopoles are proposed as part of this License. A depiction of the Equipment is also Exhibit A. In the event there are not sufficient electric and telephone, cable or fiber utility sources located at the Premises or on the Property, LICENSOR agrees to grant LICENSEE the right to install such utilities on, over and/or under the Property and to the Premises as necessary for LICENSEE to operate its Equipment, provided the location of such utilities shall be designated by LICENSOR.

This license shall be for the limited purpose of installing, attaching, operating, repairing and maintaining the Equipment and the LICENSEE shall not engage in any illegal practices, anticompetitive behavior or collusion with regard to construction activities related to the installation, operation, maintenance, transfer, repair, relocation or removal of the Equipment.

Any license granted is a revocable, non-exclusive license for the purposes set forth in this Agreement. This Agreement in no way precludes the non-discriminatory issuance of other licenses to operate communications equipment within the Village of Lombard. No use, however lengthy, of the Premises by the LICENSEE shall create or vest in the LICENSEE any easement or other ownership or property right of any nature in any portion of the LICENSOR's Property or the Premises, other than expressly stated herein.

2. PERMIT APPROVAL PROCESS. LICENSEE shall submit a permit application to LICENSOR for the Premises to install its Equipment that includes detailed engineering design drawings, including any required extensions of electric, telephone, cable, or fiber to the Premises, and specifications for the Equipment. Prior to issuance of a permit for this license, LICENSEE must provide adequate documentation to demonstrate the proposed Equipment can be structurally accommodated by the Premises. LICENSEE shall be held responsible for expenses associated with a third-party consultant's assessment of the structural installation, with said expenses not to exceed an amount equal to One Thousand and No/100 Dollars (\$1,000.00). LICENSOR shall make best efforts to review the request in a timely fashion and approve or deny the request within forty-five (45) days of submittal. Failure to receive approval in forty-five (45) days does not constitute LICENSOR's approval. Permit approval will only be given if the following criteria are met:

- a) LICENSEE shall submit a site plan that shows detailed engineering design drawings, including the size, surface area, height, and specifications of proposed installation.
- b) LICENSEE shall submit documentation that the Equipment proposed shall not interfere with any LICENSOR public safety radio system, traffic signals, light system or other telecommunications components.
- c) If the Premises is located on a light pole adjacent to the front yard of a residential building, LICENSEE shall show best alternate location. LICENSEE shall show and explain the difference in service capability between the two sites. If alternate site is preferred by LICENSOR the alternate site shall be considered.
- d) LICENSEE shall not install more than one Facility on a single utility pole.
- e) LICENSEE shall not install Equipment within one hundred (100) feet from any residential building and no closer than three hundred feet (300) from any other personal wireless telecommunication facility. A lesser setback may be allowed by the Village board as a variance when the applicant establishes that the lesser setback is necessary to close a significant gap in the applicant's services and no other viable alternative location or locations are available.
- f) Upon prior approval by the Village board and in compliance with the Village of Lombard Code of Ordinances ("Code"), LICENSEE may install Equipment on property and poles owned by another party within the corporate limits of the Village of Lombard. Such approval shall not unreasonably be withheld, delayed or denied by the Village.
- g) Surface Area of Antenna. The personal wireless telecommunication antenna, including antenna panels, whip antennas or dish-shaped antennas, shall not have a surface area of more than seven square feet and no single dimension exceeding seven feet. Omnidirectional or whip antennas may not extend more than seven feet, not including any pole extension.
- h) Minimum Height of Equipment. The LICENSEE shall locate the base of the Equipment or appurtenances at a height of no lower than eight feet above grade, not including Equipment relating to connection or disconnection switches, or power meters, provided Equipment is located on the Pole. The LICENSOR has the discretion to authorize Equipment be installed at grade, provided that screening is installed to minimize the visibility of the Equipment.
- i) Height. The top of the highest point of any antenna may not extend more than seven feet above the highest point of the Premises.

- j) Color. All Equipment shall be a color that blends with the surroundings of the Premises, on which it is mounted and use non-reflective materials which blend with the materials and colors of the surrounding area and structures. Any wiring must be covered with an appropriate cover or cable shield.
- k) Antenna Panel Covering. Any antenna shall include a radome, cap or other antenna panel covering or shield and shall be of a color that blends with the color of the Premises on which it is mounted.
- l) Wiring and Cabling. Wires and cables connecting the antenna to the remainder of the Equipment shall be installed in accordance with the version of the National Electric Code and National Electrical Safety Code adopted by the LICENSOR and in force at the time of the installation of the Facility. In no event shall wiring and cabling serving the Equipment interfere with any wiring or cabling installed by a cable television or video service operator, electric utility or telephone utility.
- m) Grounding. The Equipment shall be grounded in accordance with the requirements of the most current edition of the National Electrical Code adopted by the LICENSOR and in force at the time of the installation of the Equipment.
- n) Guy Wires. No guy or other support wires shall be used in connection with the Equipment unless the Equipment is proposed to be attached to an existing utility pole, alternative antenna support structure or Village-owned infrastructure that incorporated guy wires prior to the date that an applicant has applied for a permit.
- o) Structural Integrity. The Equipment shall be designed to withstand a wind force of at least ninety miles per hour, and be designed to withstand a wind force of at least forty miles per hour which includes at least three-quarters of an inch of ice all without the use of guy wires. The LICENSEE shall provide the LICENSOR with a structural evaluation of the Premises containing a recommendation that the proposed installation passes the standards described above. The evaluation shall be prepared by a professional structural engineer licensed in the state of Illinois.
- j) If the Premises does not meet the structural requirements, the LICENSEE may propose pole or structure reinforcement or replacement, which may be granted in the discretion of the LICENSOR. LICENSEE shall provide engineering design and specifications and drawings demonstrating any proposed alterations to or replacement of the pole or structure. LICENSEE shall replace the pole or structure with the approved design at its cost.
- k) LICENSEE shall comply with all the terms and conditions of Sections 97.055 and 97.057 of the Village Code and all other applicable provisions of the Village Code relating to construction of utility facilities.

3. CONDITION OF PREMISES. LICENSEE takes and accepts the Premises “as is” in the condition in which the LICENSEE finds the Premises, with any and all latent and patent defects and with no express or implied warranties by the LICENSOR of merchantability, fitness, suitability, or that the Premises are fit for any particular purpose. The LICENSEE shall have the right to inspect the Premises prior to installing its Equipment. The LICENSOR will be responsible for the regular maintenance of the Premises and will keep the Premises in good repair as required by all federal, state, county and local laws. The LICENSOR shall have the right to temporarily remove or require the LICENSEE to temporarily

remove the LICENSEE'S Equipment in order to maintain the Premises, upon thirty (30) days' written notice to LICENSEE.

The LICENSEE shall be responsible for repairing any damage to the Premises that is disturbed or damaged during, or as a result of, the construction, reconstruction, repair, replacement, relocation, operation or maintenance of the communications Equipment.

In the event that LICENSEE shall desire to upgrade any Equipment upon any Premises, the LICENSEE shall notify the LICENSOR in writing prior to installing any such upgrade and, upon the request of the LICENSOR, file a new Permit Application for such upgrade and provide all necessary documentation to establish compliance with the provisions of Paragraph 2 herein.

4. **GENERAL RESTRICTIONS.** In the event LICENSOR, in its sole discretion, deems it necessary to remove, relocate, repair or replace the Premises, LICENSEE shall notify LICENSOR at least thirty (30) days prior of the need to remove or relocate its Equipment, and LICENSEE shall be solely responsible for all costs related to the relocation of its Equipment. Notwithstanding the foregoing, prior to any removal or relocation of any Equipment, the LICENSOR and LICENSEE shall mutually agree and identify a suitable replacement location, and the LICENSOR and the parties shall amend this Agreement to reflect such subsequent location upon terms and conditions substantially equivalent to the terms and conditions set forth herein. In the event of an emergency, the thirty (30) day notice period shall not apply.

In no event shall the LICENSOR be obligated to replace or modify the Premises to accommodate the LICENSEE'S Equipment. If the LICENSEE desires, the LICENSEE may replace, at its sole cost and expense, the Premises in order to accommodate the Equipment, provided that the LICENSOR has authorized and approved a replacement pole. In no event shall the LICENSOR be obligated to approve or authorize the LICENSEE to install any replacement poles.

5. **TERM; LICENSE.** Subject to paragraph 7 of this Agreement, this Agreement shall be for a term of ten (10) years commencing upon the execution hereof by both Parties.

In exchange for use of the Premises pursuant to this Agreement, the LICENSEE shall pay the LICENSOR an annual rental fee in the amount of Two Thousand Four Hundred and No/100 Dollars (\$2,400.00) (the "Rent"). Thereafter, Rent will increase three percent (3%) upon each annual anniversary of the Effective Date (as hereinafter defined), and be paid in advance of each anniversary of the Effective Date thereafter. LICENSOR and LICENSEE acknowledge and agree that the Rent owed for the first year of the Term shall be due to LICENSEE within thirty (30) days after the date in which the permit is issued (the "Effective Date"). Any Rent not paid in accordance with the terms herein will be assessed a late fee of ten percent (10%) per annum from the date said payment is due.

Upon agreement of the Parties, LICENSEE may pay rent by electronic funds transfer and in such event, LICENSOR agrees to provide to LICENSEE bank routing information for such purpose upon request of LICENSEE.

LICENSOR hereby agrees to provide to LICENSEE a completed Internal Revenue Service ("IRS") Form W-9, or equivalent and other documentation necessary to comply with IRS regulations for any party to whom rental payments are to be made pursuant to this Agreement. All documentation shall be acceptable to LICENSEE in LICENSEE'S reasonable discretion.

6. **ELECTRICAL.** LICENSEE shall be permitted to connect its Equipment to necessary electrical and telephone service, at LICENSEE'S expense. LICENSEE shall coordinate with utility companies to provide separate service to LICENSEE'S Equipment for LICENSEE use. In the event that

LICENSEE can obtain separate electrical service with a separate meter measuring usage, the LICENSEE shall pay the utility directly for its power consumption, if billed directly by the utility. In the event that separate electrical service is not possible or practical under the circumstances, LICENSEE may use existing service, at LICENSEE'S expense, upon the reasonable approval of LICENSOR. In the event that LICENSEE uses existing utility service at the Premises, the Parties agree to either: (i) attempt to have a submeter installed, at LICENSEE'S expense, which shall monitor LICENSEE'S utility usage (with a reading and subsequent bill for usage delivered to LICENSEE by either the applicable utility company or LICENSOR); or (ii) provide for an additional fee which shall cover LICENSEE'S utility usage.

LICENSEE shall be permitted at any time during the Term to install, maintain and/or provide access to and use of, as necessary (during any power interruption at the Premises), a temporary power source, and all related equipment and appurtenances within the Premises, or elsewhere on the Property in such locations as reasonably approved by LICENSOR. LICENSEE shall have the right to install conduits connecting the temporary power source and related appurtenances to the Premises. In the event such conduits affect the life expectancy of the pole, an additional reasonable fee, as mutually agreed to by the Parties, which reflects the replacement cost of the pole, may be assessed by LICENSOR after providing written notice to LICENSEE.

7. EXTENSIONS. This Agreement may be extended for two (2) additional five (5) year terms unless either Party provides written notice to the other Party of its intent to terminate this Agreement at least three (3) months prior to the end of the then current term. The initial term and all extensions shall be collectively referred to herein as the "Term".

8. USE; GOVERNMENTAL APPROVALS. LICENSEE shall use the Premises for the purpose of constructing, maintaining, repairing and operating its Equipment and uses incidental thereto. LICENSEE shall have the right to replace, repair the Equipment and the frequencies over which the Equipment operates. It is understood and agreed that LICENSEE'S ability to use the Premises is contingent upon its obtaining all of the certificates, permits and other approvals (collectively, the "Governmental Approvals") that may be required by any Federal, State or Local authorities, as well as a satisfactory structural analysis which will permit LICENSEE use of the Premises as set forth above. In the event that (i) any of such applications for such Governmental Approvals should be finally rejected; (ii) any Governmental Approval issued to LICENSEE is canceled, expires, lapses, or is otherwise withdrawn or terminated by governmental authority; and (iii) LICENSEE determines that such Governmental Approvals may not be obtained in a timely manner, LICENSEE shall have the right to terminate this Agreement. Additionally, if LICENSEE determines that the Premises is no longer technically viable, LICENSEE shall have the right to terminate this Agreement and remove its Equipment from the Property and Premises. Notice of LICENSEE'S exercise of its right to terminate shall be given to LICENSOR within thirty (30) days of LICENSEE obtaining knowledge of its need to terminate and shall be effective upon the mailing of such written notice by LICENSEE, or upon such later date as designated by LICENSEE. All Rent or other fees paid prior to said termination date shall be retained by LICENSOR. Upon such termination, this Agreement shall be of no further force or effect, subject to any surviving representations, warranties and indemnities contained herein. Notwithstanding anything to the contrary in this Section 8, LICENSEE shall continue to be liable for all Rent and other payments due to the LICENSOR until all Equipment is removed from the Property and Premises.

9. INSURANCE.

a. LICENSEE shall procure and maintain for the duration of this Agreement, insurance against claims for injuries to persons or damages to property, which may arise from or in connection with LICENSEE'S operation and use of the Premises. The cost of such insurance shall be borne by LICENSEE, and shall be in the following coverage and amounts:

1. Commercial General Liability Coverage covering Comprehensive General Liability and Insurance Services covering Broad Form Comprehensive General Liability, or the most recent revision thereof, covering LICENSEE and insuring the LICENSOR and its officers, officials, employees, volunteers and agents, as additional insured's as respects liability arising out of the Premises and the Equipment, and/or arising out of activities performed by or on behalf of LICENSEE. Said insurance coverage shall be primary as respects liability assumed by LICENSEE, its officers, officials, employees, volunteers and agents.

Any insurance maintained by the LICENSOR, its officers, officials, employees, volunteers and agents shall be in excess of LICENSEE'S insurance and shall not contribute with it, but only with respect to liability assumed by LICENSEE under this Agreement. LICENSEE shall maintain limits of not less than One Million and 00/100 Dollars (\$1,000,000.00) combined single limit for any one occurrence for bodily injury, personal injury and property damage. LICENSEE shall furnish a Certificate of the Owner's and Contractor's Protective Policy Liability policy ("OCP") meeting the terms and conditions herein, including, without limitation, regarding coverage, minimum amounts and types of coverage, acceptability of insurance, additional insured's, cancellation and modification. All insurance shall be from any insurance company or companies authorized to do business in Illinois with a policy holder's rating of at least an "A minus" and a financial rating of at least "VII" in the latest edition of the Best Insurance Guide.

2. Worker's Compensation and Employers' Liability: Workers compensation limits as required by statute and Employers' Liability limits of One Million and 00/100 Dollars (\$1,000,000.00) per accident and One Million and 00/100 Dollars (\$1,000,000.00) per disease.

3. Automobile liability insurance covering all owned, hired, and non-owned vehicles in use by LICENSEE, its employees and agents, with personal protection insurance and property protection insurance to comply with the provisions of State law and minimum limits of One Million and 00/100 Dollars (\$1,000,000.00) as the combined single limit occurrence for bodily injury and property damage.

b. All policies, other than those for Worker's Compensation, shall be written on an occurrence and not on a claims made basis.

c. LICENSEE shall, prior to the Effective Date and prior to the installation of any of its Equipment and from time to time at the LICENSOR'S reasonable request during the Term, furnish to the LICENSOR certificates evidencing such coverage, which certificates shall state that such insurance coverage may not be changed or canceled without at least thirty (30) days' prior written notice to the LICENSOR.

d. LICENSEE shall not use or occupy the Premises, or permit the Premises to be used or occupied contrary to any statute, rule, order, ordinance, requirement or regulation applicable thereto, or in any manner which would cause structural injury to the Premises or which would constitute a public or private nuisance or waste.

10. LIMITATION OF LIABILITY Except as set forth in this Agreement, neither Party shall be liable to the other, or any of their respective agents, representatives, employees for any lost revenue, lost profits, loss of technology, rights or services, incidental, punitive, indirect, special or consequential damages, loss of data, or interruption or loss of use of service, even if advised of the possibility of such damages, whether under theory of contract, tort (including negligence), strict liability or otherwise.

The LICENSOR shall not be liable to the LICENSEE, its customers, or anyone else for the interruption of service of the LICENSEE or any interference with the operation of the LICENSEE'S Equipment.

11. INDEMNIFICATION. Except for matters arising out of the LICENSOR'S negligence or willful misconduct, LICENSEE and any agent, employee, contractor, or subcontractor of the LICENSEE shall defend, indemnify and hold harmless the LICENSOR and its officials, officers, board members, employees, agents, attorneys and contractors (collectively, the "Indemnitees") against any and all claims, causes of action, proceedings, judgments for damage or equitable relief arising in any way, including any act, omission, failure, negligence or willful misconduct in connection to the construction, repair, installation, maintenance, presence, use, relocation, transfer, removal or operation of the Equipment or the use of the Premises by the LICENSEE or by the LICENSEE'S officers, directors, employees, agents, contractors or subcontractors of the LICENSEE.

12. INTERFERENCE. LICENSEE agrees that its license is subject at all times to the LICENSOR'S right to use the Premises for its primary purpose. LICENSEE agrees to install Equipment of the type and frequency which will not cause harmful interference which is measurable in accordance with the existing industry standards to any Equipment of LICENSOR or government agency, or other licensees of the Property which existed on the Property prior to the Effective Date. In the event any after-installed LICENSEE'S Equipment causes such interference, and after LICENSOR has notified LICENSEE in writing of such interference, LICENSEE will take all reasonable steps necessary to correct and eliminate the interference, including but not limited to, at LICENSEE'S option, powering down the Equipment and later powering up such Equipment for intermittent testing. LICENSOR agrees that LICENSOR and/or any other present or future licensees of the Premises will be permitted to install only such Equipment that is of the type and frequency which will not cause harmful interference which is measurable in accordance with then-existing industry standards to the then existing Equipment of LICENSEE. The Parties acknowledge that there will not be an adequate remedy at law for noncompliance with the provisions of this Section and therefore, either Party shall have the right to equitable remedies, such as, without limitation, injunctive relief and specific performance.

13. REMOVAL AT END OF TERM. LICENSEE shall, within ninety (90) days of the expiration of the Term, or within ninety (90) days after any earlier termination of this Agreement, remove its Equipment, and restore the Premises to its original condition, reasonable wear and tear and casualty damage excepted. LICENSOR agrees and acknowledges that all of the Equipment of LICENSEE shall remain the personal property of LICENSEE and LICENSEE shall have the right to remove the same at any time during the Term, whether or not said items are considered fixtures and attachments to real property under applicable laws. If such time for removal causes LICENSEE to remain on the Premises after ninety (90) days following the termination of this Agreement, LICENSEE shall pay rent at one hundred and fifty percent (150%) of the then-existing monthly rate, until such time as the removal of the Equipment is completed.

14. NO WAIVER OF DUTIES. Termination of this Agreement does not relieve LICENSEE from the obligation (i) to pay any amounts due and owing to LICENSOR under the Agreement at the time of termination, or (ii) concerning any claim for damages against LICENSEE under this Agreement. LICENSOR'S rights, options, and remedies under this Agreement are cumulative, and non-exclusive. LICENSOR may pursue any or all such remedies or any other remedy or relief provided by law, whether or not stated in this Agreement. No waiver by LICENSOR of a breach of any covenant or condition of this Agreement is a waiver of any subsequent breach of the same or any other covenant or condition of this Agreement.

15. RIGHTS UPON SALE. Should LICENSOR, at any time during the Term of this Agreement decide to sell or transfer all or any part of the Property or interest in the Property thereof, such sale or transfer of interest therein shall be under and subject to the Agreement and any such purchaser or transferee shall recognize LICENSEE'S rights hereunder and under the terms of the Agreement. In the event of such sale or transfer, LICENSOR shall provide thirty (30) days' written notice to LICENSEE.

16. REMOVAL FOR NON-COMPLIANCE. The LICENSOR shall have the authority at any time to order and require LICENSEE to remove and abate any Equipment that is in violation of the LICENSOR's Code upon written notice to LICENSEE. In the event LICENSEE, after receipt of written notice of such violation, fails to cure such violation within thirty (30) days after receipt of notice thereof, or fails to diligently and in good faith cure such violation, where such remedy requires more than thirty (30) days to complete, the LICENSOR may remove the same at the expense of the LICENSEE, all without compensation or liability for damages to LICENSEE.

17. LIMITED RIGHT OF ASSIGNMENT. This Agreement may be assigned by LICENSEE without any approval or consent of the LICENSOR to LICENSEE'S principal, affiliates, subsidiaries of its principal or to any entity which acquires all or substantially all of LICENSEE'S assets in the market defined by the FCC in which the Premises or Property is located by reason of a merger, acquisition or other business reorganization provided that such acquiring entity is bound by all of the terms and conditions of this Agreement. As to other parties, this Agreement may not be sold or assigned without the written consent of the LICENSOR, which shall not be unreasonably withheld. LICENSEE shall provide the LICENSOR with written notice of any such merger, acquisition or other business reorganization with a principal, Affiliate or subsidiary of LICENSEE within a reasonable period of time prior to the consummation thereof. The parties agree and acknowledge that, notwithstanding anything in this Agreement to the contrary, certain Equipment deployed by LICENSEE in the Rights-of-Way pursuant to this Agreement may be owned and/or operated by LICENSEE'S third-party wireless carrier customers ("Carriers") and installed and maintained by LICENSEE pursuant to license agreements between LICENSEE and such Carriers. Such Equipment shall be treated as LICENSEE'S Equipment for all purposes under this Agreement provided that (i) LICENSEE remains responsible and liable for all performance obligations under the Agreement with respect to such Equipment; (ii) LICENSOR's sole point of contact regarding such Equipment shall be LICENSEE; and (iii) LICENSEE shall have the right to remove and relocate the Equipment.

18. NOTICES. All notices hereunder must be in writing and shall be deemed validly given if sent by certified mail, return receipt requested or by commercial courier, provided the courier's regular business is delivery, addressed as follows (or any other address that the Party to be notified may have designated to the sender by like notice):

LICENSOR: Village of Lombard
255 East Wilson
Lombard, Illinois 60148

LICENSEE: Mobilitie, LLC
Attn: Asset Management and Legal Department
660 Newport Center Drive, Suite 200
Newport Beach, CA 92660
877-999-7070
assetmgmt@mobilitie.com (Asset Management); and
legal@mobilitie.com (Legal)

WITH A COPY TO:

Thomas P. Bayer

Klein, Thorpe & Jenkins, Ltd.
20 N. Wacker Dr. Ste 1660
Chicago, IL 60606

Notice shall be effective upon actual receipt or refusal as shown on the receipt obtained pursuant to the foregoing.

19. DEFAULT.

a. The following events shall be deemed to be events of default under this Agreement ("Event of Default"):

1. LICENSEE'S failure to pay Rent as provided in this Agreement or any other amount due and owing within thirty (30) days following LICENSEE'S receipt of notice thereof;

2. LICENSEE'S failure to comply with any provision of this Agreement within thirty (30) days following LICENSEE'S receipt of notice thereof;

3. Any material representation made by LICENSEE in this Agreement, or in any certificate, notice, demand response or request made in writing and delivered to the LICENSOR or any Governmental Authority pursuant to or in connection with this Agreement or any documents in furtherance thereof, which shall be untrue or incorrect in any material respect as of the date made;

4. LICENSEE abandons the Premises, which shall be defined as the failure to use the Equipment upon the Premises for wireless telecommunications for a period of six (6) months;

5. The entry of a decree or order for relief by a court having jurisdiction in an involuntary case under the federal bankruptcy laws, as now or hereafter constituted, or any other applicable federal or state bankruptcy, insolvency or other similar law, or appointing a receiver, liquidator, assignee, custodian, trustee, (or similar official) of LICENSEE for any substantial part of its property, or ordering the winding-up or liquidation of its affairs and the continuance of any such decree or order unstayed and in effect for a period of sixty (60) consecutive days;

6. The commencement by LICENSEE of a voluntary case under the federal bankruptcy laws, as now or hereafter constituted, or any other applicable federal or state bankruptcy, insolvency or other similar law, or the consent by LICENSEE to the appointment of or taking possession by a receiver, liquidator, assignee, trustee, custodian, (or similar official) of LICENSEE or of any substantial part of the Premises, or the making by any such entity of any assignment for the benefit of creditors or the failure of LICENSEE generally to pay such entity's debts as such debts become due or the taking of action by LICENSEE in furtherance of any of the foregoing, or a petition is filed in bankruptcy by others and not dismissed within thirty (30) consecutive days; and

7. LICENSOR'S failure to comply with any provision of this Agreement.

b. In the event either Party to this Agreement should fail to perform or avoid its obligations herein, the Party not in breach shall provide written notice to the Party in breach setting forth the action or failure to act that constitutes the breach of this Agreement. If the breaching Party (a) fails to cure the breach within thirty (30) days after the receipt of written notice thereof; or (b) fails to diligently and in good faith commence to cure, where such breach is curable, but requires more than thirty (30) days to cure, the non-breaching Party may terminate this Agreement in addition to any other rights or remedies which may be available at law or in equity.

c. If LICENSEE fails to perform any obligations hereunder beyond any period allowed hereby for cure, after written notice has been provided as required herein, the LICENSOR may enter the Premises and perform it on LICENSEE'S behalf. In so doing, the LICENSOR may, but shall not be required to, make any payment of money or perform any other act. All sums paid by the LICENSOR, and all incidental costs and expenses, shall be due and payable by LICENSEE to the LICENSOR within thirty (30) days of written notice thereof, together with interest from the date of demand to the date of payment at the "Interest Rate". For purposes of this Agreement, the Interest Rate shall mean one percent (1%) per month on any unpaid balance due, it being understood, however, that in no event shall such Interest Rate exceed the maximum interest rate permitted by state law.

20. **REMEDIES.** In the event of a default by either Party, without limiting the non-defaulting Party in the exercise of any right or remedy which the non-defaulting Party may have by reason of such default, the non-defaulting Party may terminate this Agreement and/or pursue any remedy now or hereafter available to the non-defaulting Party under the Laws or judicial decisions of the state in which the Premises are located. Further, upon a default, the non-defaulting Party may at its option (but without obligation to do so), perform the defaulting Party's duty or obligation on the defaulting Party's behalf, including but not limited to the obtaining of reasonably required insurance policies. The costs and expenses of any such performance by the non-defaulting Party shall be due and payable by the defaulting Party within thirty (30) days following the receipt of an invoice indicating such expenses. This Agreement shall be governed interpreted, construed and regulated by the laws of the state of Illinois. The Circuit Court of the 16th Judicial Circuit shall have jurisdiction and venue over any dispute with respect to this Agreement.

21. **ENVIRONMENTAL.** LICENSOR will be responsible for all obligations of compliance with any and all environmental and industrial hygiene laws, including any regulations, guidelines, standards, or policies of any governmental authorities regulating or imposing standards of liability or standards of conduct with regard to any environmental or industrial hygiene conditions or concerns as may now or at any time hereafter be in effect, that are or were in any way related to activity now conducted in, on, or in any way related to the Premises, unless such conditions or concerns are caused by LICENSEE'S specific activities or failures to act. To the extent permitted by law, LICENSOR shall hold LICENSEE harmless and indemnify LICENSEE from and assume all duties, responsibility and liability at LICENSOR'S sole cost and expense, for: (i) breach of any environmental compliance obligations on the Premises to the extent that such non-compliance results from conditions are not caused by LICENSEE; and (ii) any environmental or industrial hygiene conditions arising out of or in any way related to the condition of the Property or activities conducted thereon, to the extent that such environmental conditions are not caused by LICENSEE. LICENSEE shall hold LICENSOR harmless and indemnify LICENSOR at LICENSEE'S sole cost and expense, for all duties, responsibilities, and liability (for payment of penalties, sanctions, forfeitures, losses, costs, or damages) and for responding to any action, notice, claim, order, summons, citation, directive, litigation, investigation or proceeding which is in any way related to: (i) failure to comply with any environmental or industrial hygiene law, including without limitation any regulations, guidelines, standards, or policies of any governmental authorities regulating or imposing standards of liability or standards of conduct with regard to any environmental or industrial hygiene concerns or conditions as may now or at any time hereafter be in effect, to the extent that such non-compliance results from conditions caused by LICENSEE; and (ii) any environmental or industrial hygiene conditions arising

out of or in any way related to the condition of the Premises or activities conducted thereon, to the extent that such environmental conditions are caused by LICENSEE.

22. CASUALTY. In the event of damage by fire or other casualty to the Premises that cannot reasonably be expected to be repaired within forty-five (45) days following same or, if the Premises is damaged by fire or other casualty so that such damage may reasonably be expected to disrupt LICENSEE'S operations at the Premises for more than forty-five (45) days, then LICENSEE may, at any time following such fire or other casualty, provided LICENSOR has not completed the restoration required to permit LICENSEE to resume its operation at the Premises, terminate the Agreement upon fifteen (15) days prior written notice to LICENSOR. Any such notice of termination shall cause the Agreement to expire with the same force and effect as though the date set forth in such notice were the date originally set as the expiration date of the Agreement and the Parties shall make an appropriate adjustment, as of such termination date, with respect to payments due to the other under the Agreement. Notwithstanding the foregoing, the Rent shall abate during the period of repair following such fire or other casualty in proportion to the degree mutually determined by the Parties to which LICENSEE'S use of the Premises is impaired.

23. APPLICABLE LAWS. During the Term, LICENSOR shall maintain the Premises in compliance with all applicable laws, rules, regulations, ordinances, directives, covenants, easements, zoning and land use regulations, and restrictions of record, permits, building codes, (collectively, "Laws"). LICENSEE shall, in respect to the condition of the Premises and at LICENSEE'S sole cost and expense, comply with (i) all Laws relating solely to LICENSEE'S specific and unique nature of use of the Premises; and (ii) all building codes requiring modifications to the Premises due to the improvements being made by LICENSEE in the Premises.

24. BOND; CASH ESCROW. LICENSEE shall deposit with LICENSOR on one occasion prior to executing this Agreement, a bond in a form reasonably acceptable to LICENSOR in the amount of Ten Thousand and No/100 Dollars (\$10,000.00), to guarantee the safe and efficient removal of any Equipment from the Premises, which Equipment remains more than ninety (90) days after the payment Rent has ceased and LICENSEE has failed to remove the Equipment. The funds may also be used to restore the Premises to its original condition, if LICENSEE fails to do so within sixty (60) days of receipt of notice. The time frame to complete restoration may be extended based on unforeseen circumstances or by mutual agreement.

25. MISCELLANEOUS. This Agreement hereunder contain all agreements, promises and understandings between the LICENSOR and the LICENSEE regarding this transaction, and no oral agreement, promises or understandings shall be binding upon either the LICENSOR or the LICENSEE in any dispute, controversy or proceeding. This Agreement may not be amended or varied except in a writing signed by all Parties. This Agreement shall extend to and bind the heirs, personal representatives, successors and assigns hereto. The failure of either Party to insist upon strict performance of any of the terms or conditions of this Agreement, or to exercise any of its rights hereunder, shall not waive such rights and such Party shall have the right to enforce such rights at any time. The performance of this Agreement shall be governed interpreted, construed and regulated by the laws of the state of Illinois.

26. AUTHORIZATION. LICENSEE certifies and warrants that it has the authority to enter into this Agreement.

IN WITNESS WHEREOF, the Parties hereto have set their hands and affixed their respective seals the day and year first above written.

LICENSOR:

**Village of Lombard, an Illinois
municipal corporation**

By: 
Its: Village President
Date: December 7, 2017

WITNESS



LICENSEE:

Mobilitie, LLC

By: 

WITNESS

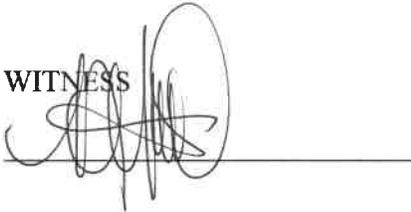



EXHIBIT A
Premises and Equipment

EQUIPMENT CHART

QTY.	DESCRIPTION	MANUFACTURER	MODEL NUMBER	CABLE	DIMENSIONS (HAWK)	WEIGHT
1	ANTENNA	PLASMA ANTENNAS	LONG SEA S3000	16'±	35.4" X 4.7" DIAMETER	11 LBS
1	UE RELAY	AIRSPAN	IR400-3P9-S1-1-J-O	3'±	13" X 7" DIAMETER	8.8 LBS
1	GPS	TALLYSMAN	TR5012	-	-	-
1	RADIO	AIRSPAN	AH4000/HAH40	3'±	6.8" X 2.6" DIAMETER	0.5 LBS
1	AC DISTRIBUTION PANEL	TRANSPECTOR	1101-1207-1012	1'±	20.5" X 10.3" X 8.3"	4.8 LBS
1	METER SOCKET	MILBANK	U4801-XL-6TB	202'±	19" X 13" X 4.94"	21 LBS
1	NEMA TYPE-3R DISCONNECT	SQUARE D	D221NRB	1'±	9.83" X 7.28" X 3.70"	4.82 LBS

BILL OF MATERIALS
 SCALE: NOT TO SCALE

2

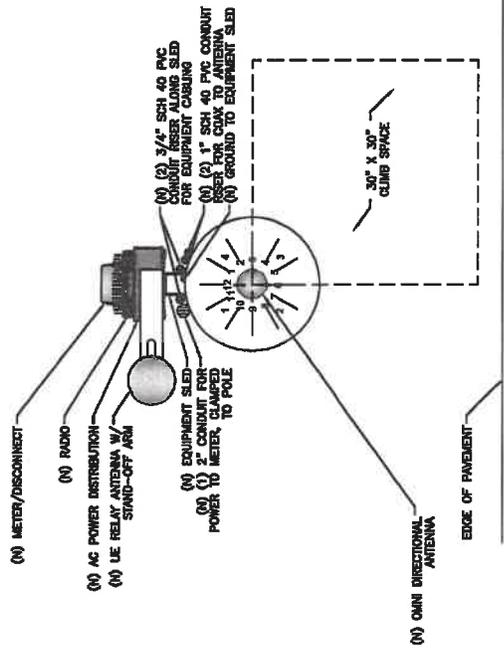

RISER ORIENTATION DIAGRAM
 SCALE: NOT TO SCALE

3


NOTE:
 CABLEING DIAGRAM IS FOR CLARITY OF CABLEING ROUTE FROM EQUIPMENT TO CONDUIT. ALL CABLES SHALL BE INSTALLED WITH MINIMAL VISUAL IMPACT ON (E) STEEL POLE. SEE ELEVATION DRAWING FOR EQUIPMENT AND ANTENNA LOCATIONS.

NOTE:
 REFER TO STRUCTURAL ANALYSIS REPORT (SEPARATE DOCUMENT) FOR ADDITIONAL STRUCTURAL INFORMATION.

- CABLEING NOTES:**
- WOOD, CONCRETE AND EXISTING METALLIC POLES FROM GRADE LINE TO 11'-0" ABOVE GRADE. ALL CABLES/CONDUCTORS EXCEPT GROUNDING CONDUCTOR MUST RUN IN RIGID GALVANIZED STEEL CONDUIT (RGS) BEING PROVIDED.
 - GROUNDING CONDUCTORS IN EXPOSED LOCATIONS MUST BE INSTALLED IN PVC.
 - IN EARTH INSTALL PVC CONDUIT FOR BACKHAUL AND ELECTRICAL SERVICE. TRANSITION TO RGS AT GRADE LINE.
 - ABOVE 11'-0" ALL CABLES (POWER, ETHERNET, CANNAUL) MUST RUN IN PVC UTILITY POLE RISER.
 - AT MAJOR EQUIPMENT EXTEND UTILITY DUCT IMMEDIATELY ADJACENT TO THE EQUIPMENT. INSTALL CABLES IN THE UTILITY POLE RISER CREATING CABLE DROP LOOPS NOT LESS THAN THE CABLE BEING PROVIDED.
 - INSIDE THE UTILITY POLE RISER, UTILIZE 1/2" DIA. POWER CABLE RUN INSIDE PVC RISER ATTACHED TO POLE GALVANIZED STEEL CONDUIT TO THE AC DISTRIBUTION BOX. EXAMPLE: UTILITY-REQUIRED DISCONNECT ON POLE W/ AC DISTRIBUTION BOX ON OPPOSITE SIDE OF POLE.
 - NEW METALLIC POLES
 - PROCURE NEW POLES WITH SUITABLE HAND HOLES SUCH THAT HAND HOLES EXIST AT ALL EQUIPMENT LOCATIONS.
 - WITH CLIENT APPROVAL IN SELECT CASES TO FACILITATE IMPROVED APPEARANCE, 1/2" CONICAL CABLES MAY BE "SUPERSEDED" IN L&L OF LIF-4.
 - WHERE POSSIBLE, INSTALL POLE BASE SUCH THAT THE ELECTRICAL FEED AND BACKHAUL (IF UNDERGROUND) CIRCUIT ENTER THE POLE THROUGH THE POLE BASE. IF A DISCONNECTING MEANS SEPARATE FROM THE AC UTILITY, THE DISCONNECTING MEANS SHALL BE INSTALLED ON UTILITY WITH APPROVAL IN SELECT CASES. UTILITY-REQUIRED FLEXIBLE METALLIC CONDUIT (LFMC) MAY BE USED IN LENGTHS NOT TO EXCEED 36" TO EXTEND THE ELECTRICAL SERVICE CONDUIT TO THE AC DISTRIBUTION BOX.

PLUMBING DIAGRAM
 SCALE: NOT TO SCALE

1

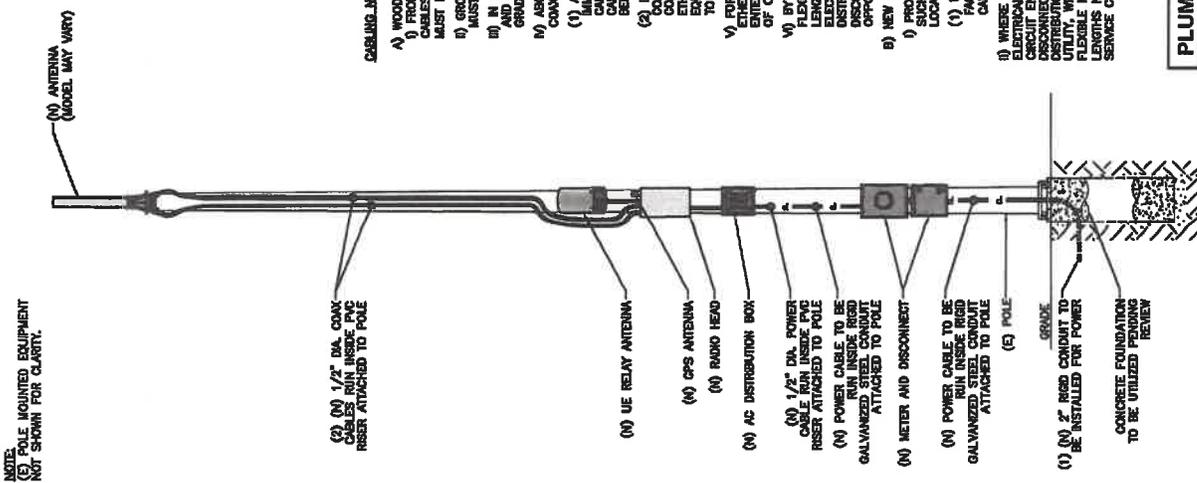

mobilitee
120 S RIVERSIDE PLAZA,
CHICAGO, IL 60608
PHONE: (312) 638-6400

PROJECT NO: BR00001
DRAWN BY: F. ARBOO
CHECKED BY: M. BARTONICK

PRELIM - NOT FOR CONSTRUCTION

1	DETAIL	FRONT	SCALE	N.T.S.
2	DETAIL	FRONT	SCALE	N.T.S.
3	DETAIL	FRONT	SCALE	N.T.S.
4	DETAIL	FRONT	SCALE	N.T.S.
5	DETAIL	FRONT	SCALE	N.T.S.
6	DETAIL	FRONT	SCALE	N.T.S.
7	DETAIL	FRONT	SCALE	N.T.S.
8	DETAIL	FRONT	SCALE	N.T.S.
9	DETAIL	FRONT	SCALE	N.T.S.
10	DETAIL	FRONT	SCALE	N.T.S.
11	DETAIL	FRONT	SCALE	N.T.S.
12	DETAIL	FRONT	SCALE	N.T.S.



CHRO057020
801 B0011280
S MEYERS RD
LOMBARD, IL 60148
LIGHT POLE

SHEET TITLE
EQUIPMENT DETAILS

SHEET NUMBER
EQ-1

MANUFACTURER: TRANSTECTOR
MODEL: TR1207-1012
HEIGHT: 12 IN
WIDTH: 12 IN
DEPTH: 4 IN
WEIGHT: 11 LBS

FRONT
SIDE
BOTTOM

MANUFACTURER: SQUARE-D
MODEL: D22NRS
HEIGHT: 8.63 IN
WIDTH: 7.25 IN
DEPTH: 3.75 IN
WEIGHT: 4.82 LBS

PLAN
FRONT
SIDE

MANUFACTURER: MILBANK
MODEL: M1000-3R
HEIGHT: 9.9 IN
WIDTH: 4.84 IN
DEPTH: 2.1 LBS

PLAN
FRONT
SIDE

MANUFACTURER: AIRSPAN
MODEL: IR460-SPB-ST-1-P-0
HEIGHT: 13 IN
WIDTH: 11 1/8 IN
DEPTH: 8.1 LBS

ELEVATION
DETAIL B

MANUFACTURER: TALLYSMAN
MODEL: TALLYSMAN
HEIGHT: 8.8 IN
WIDTH: 3.1 LBS

ELEVATION
PLAN
SIDE

MANUFACTURER: FAITH
MODEL: T80
HEIGHT: 11.5 IN
WIDTH: 11.5 IN
DEPTH: 11 IN
WEIGHT: 7.8 LBS

PLAN
FRONT
SIDE
ISOMETRIC

MANUFACTURER: AIRSPAN
MODEL: AH4000
HEIGHT: 20.3 IN
WIDTH: 20.3 IN
DEPTH: 10.3 IN
WEIGHT: 4.2 LBS

PLAN
FRONT
SIDE

MANUFACTURER: AIRSPAN
MODEL: SBA SC-800
HEIGHT: 35 IN
WIDTH: 4.7 IN
DEPTH: 11 LBS

FRONT
PLAN
BOTTOM

MANUFACTURER: AIRSPAN
MODEL: T80
HEIGHT: 11.5 IN
WIDTH: 11.5 IN
DEPTH: 11 IN
WEIGHT: 7.8 LBS

PLAN
FRONT
SIDE

MANUFACTURER: AIRSPAN
MODEL: AH4000
HEIGHT: 20.3 IN
WIDTH: 20.3 IN
DEPTH: 10.3 IN
WEIGHT: 4.2 LBS

PLAN
FRONT
SIDE

MANUFACTURER: AIRSPAN
MODEL: SBA SC-800
HEIGHT: 35 IN
WIDTH: 4.7 IN
DEPTH: 11 LBS

FRONT
PLAN
BOTTOM

MANUFACTURER: AIRSPAN
MODEL: T80
HEIGHT: 11.5 IN
WIDTH: 11.5 IN
DEPTH: 11 IN
WEIGHT: 7.8 LBS

PLAN
FRONT
SIDE

PLASMA SBA SC-800 OMNI (B41) SCALE N.T.S. 1

AIRSPAN RADIO AH4000 SCALE N.T.S. 2

AIRSPAN SUN SHIELD SCALE N.T.S. 3

UE RELAY IR460-SPB-ST-1-P-0 SCALE N.T.S. 4

NOT USED SCALE N.T.S. 7

IR460 FLUSH MOUNT SCALE N.T.S. 8

TRANSTECTOR 1101-1207-1012 SCALE N.T.S. 10

DETAIL A SCALE N.T.S. 11

MILBANK TYPE-3R DISCONNECT SCALE N.T.S. 12




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CH80287920
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 22ND ST &
 S MEYERS RD
 LOMBARD, IL 60148
 LIGHT POLE

SHEET TITLE
 ELECTRICAL DETAILS

SHEET NUMBER
 E-1

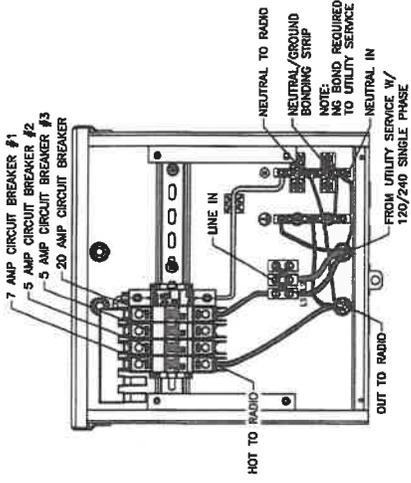

**TRANSECTOR EXPORT
 AC DISTRIBUTION BOX**


BREAKER SCHEDULE
 SCALE: NOT TO SCALE

- NOTES:**
1. AIRHARMONY 1000: MAX CURRENT FROM RATED CURRENT ON UL EQUIVALENT GRANT. MAX POWER CALCULATED FROM MAX CURRENT X 120 VOLT. MAX CURRENT FROM RATED CURRENT ON UL EQUIVALENT GRANT. MAX POWER CALCULATED FROM MAX CURRENT X 120 VOLT. MAX CURRENT FROM RATED CURRENT ON UL EQUIVALENT GRANT. MAX POWER CALCULATED FROM MAX CURRENT X 120 VOLT.
 2. AIRHARMONY 4000: MAX CURRENT FROM RATED CURRENT ON UL EQUIVALENT GRANT. MAX POWER CALCULATED FROM MAX CURRENT X 120 VOLT. MAX CURRENT FROM RATED CURRENT ON UL EQUIVALENT GRANT. MAX POWER CALCULATED FROM MAX CURRENT X 120 VOLT.
 3. MAX POWER BY MINIMAL OPERATING VOLTAGE. KVA IS CALCULATED ASSUMING PF=1 AND USING MAX POWER.
 4. MAX POWER BY MINIMAL OPERATING VOLTAGE. KVA IS CALCULATED ASSUMING PF=1 AND USING MAX POWER.
 5. MAX POWER BY MINIMAL OPERATING VOLTAGE. KVA IS CALCULATED ASSUMING PF=1 AND USING MAX POWER.
 6. FASTBACK 18R-121-3R: CONSUMPTION ACCOUNTED FOR IN PILE NEUTRAL LOSS-1 AND USING MAX POWER.
 7. FASTBACK 18R-AG-POK: MAX POWER OUTPUT FROM GEN DATA SHEET. MAX CURRENT IS CALCULATED AS MAX POWER OUTPUT DIVIDED BY MINIMAL OPERATING VOLTAGE. KVA IS CALCULATED ASSUMING PF=1 AND USING MAX POWER.
 8. AIRSPAN 18460: CONSUMPTION ACCOUNTED FOR IN RADIO CONSUMPTION.

Atrengem Scenario 2 AIR4000 High Power Radio and UE Backhaul

Unit	60.0 dBm/100W	(W)	Current (A)	KVA	(MW) Per
AirHarmony 4000	LTE Base Station	540	4.50	0.54	4730.4
Airspan BR460	UE Relay	N/A	N/A	0	0
Total		540	4.50	0.54	4730.4

LOAD CALCULATIONS
 SCALE: NOT TO SCALE

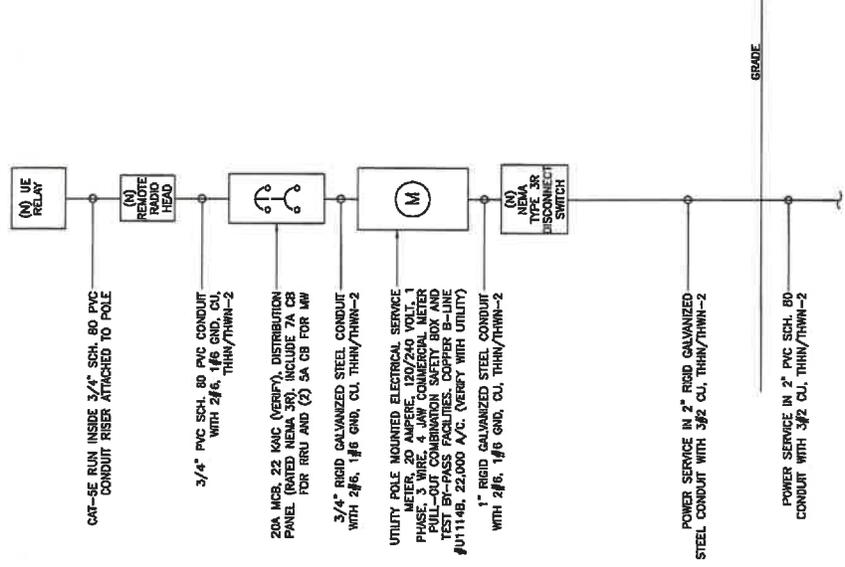


ONE-LINE DIAGRAM
 SCALE: NOT TO SCALE

2

3

1

A	12.14.12	PRELIM - NOT FOR CONSTRUCTION
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CH00457020
 91180011280
 22ND ST. A
 S METERS RD
 LOMBARD, IL 60148
 LIGHT POLE

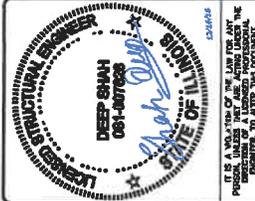
SHEET TITLE
GROUNDING DETAILS

SHEET NUMBER
G-1

- LEGEND**
- CASHELD CONNECTION
 - MECHANICAL CONNECTION
 - COMPRESSION CONNECTION


NOTE:
 GROUNDING RISER FOR DIAGRAMMATIC PURPOSES ONLY. SEE ELEVATION DRAWING FOR EQUIPMENT AND ANTENNA LOCATIONS.

- NOTES:**
- ALL RGS TO BE GROUNDING AT BOTH ENDS USING GROUNDING BUSHINGS
 - GROUND WIRE TO BE RUN IN 1/2" SCHEDULE 40 PVC.

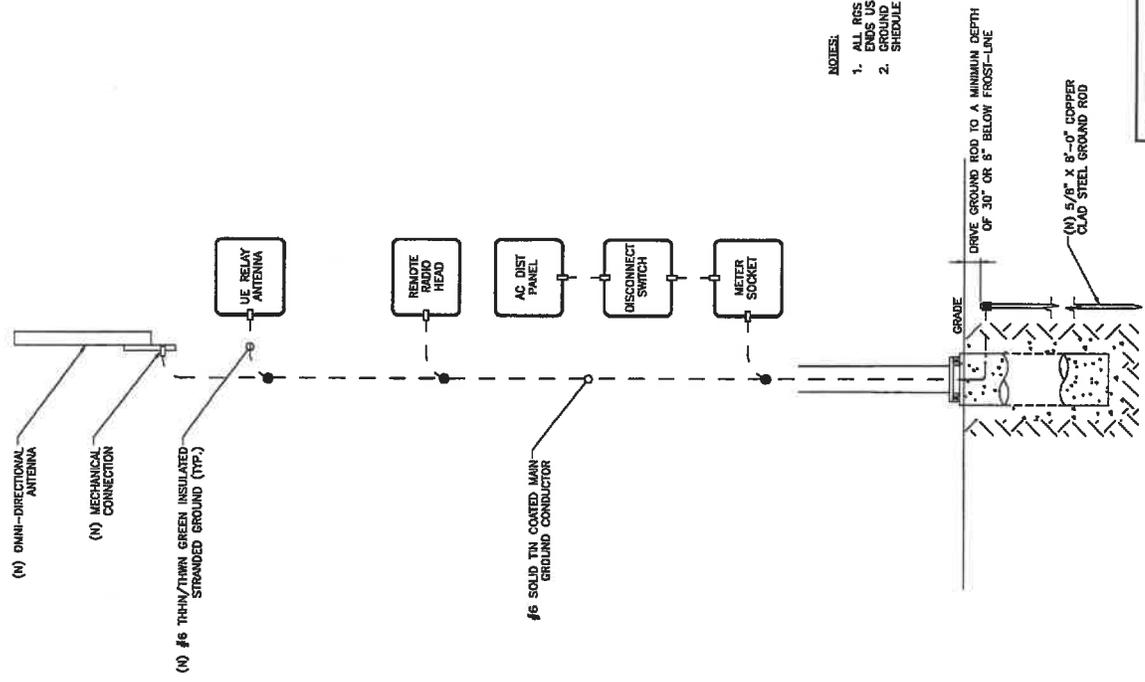

GROUNDING RISER DIAGRAM
 SCALE: NOT TO SCALE

NOTE:
 CONNECTOR TO SURROUND COMPLETED CONNECTION WITH HEAT-SHRINK TUBING TO ENSURE WEATHER PROOF CONNECTION

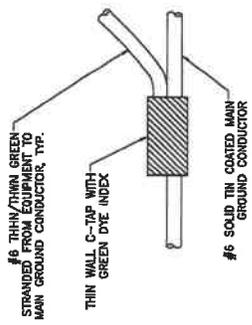


C-TAP DETAIL
 SCALE: NOT TO SCALE

- | | | | | | |
|--|-------------|--|---------|--|---------|
| | TYPE 1S | | TYPE 1A | | TYPE 1B |
| | TYPE 2-1A-2 | | TYPE 1C | | TYPE 1D |
| | TYPE 1E | | TYPE 1F | | TYPE 1G |
| | TYPE 1H | | TYPE 1I | | TYPE 1J |
| | TYPE 1K | | TYPE 1L | | TYPE 1M |

NOTE:
 ERICO EXOTHERMIC "MOLD TYPES" SHOWN HERE ARE EXAMPLES. CONSULT WITH PROJECT MANAGER FOR SPECIFIC MOLDS TO BE USED FOR THIS PROJECT.

WELD CONNECTION DETAILS
 SCALE: NOT TO SCALE

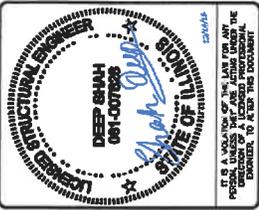

CH8025762D
 911 9001128D
 S METERS RD
 LOMBARD, IL 60148
 LIGHT POLE

SHEET TITLE
 VEHICULAR TRAFFIC CONTROL PLAN

SHEET NUMBER
 TC-1

- PLAN NOTES:**
- PLANS DEPICTED ARE GENERAL GUIDELINES FOR TEMPORARY VEHICULAR TRAFFIC CONTROL PLANS (TCP) TO INCLUDE PEDESTRIAN AND WORKER SAFETY. CONTRACTOR IS REQUIRED TO HAVE PREPARED A SITE-SPECIFIC TCP FOR REVIEW AND APPROVAL BY THE HIGHWAY AUTHORITY HAVING JURISDICTION. IF REQUIRED, THE FIRM PREPARING THE TCP SHALL BE AUTHORIZED OR CERTIFIED BY THE AUTHORITY HAVING JURISDICTION.
 - EXTEND CHANNELIZATION DEVICES INTO SHOULDER WHERE APPLICABLE.
 - DISTANCES AS INDICATED IN TABLE 1 SHOULD BE INCREASED FOR CONDITIONS THAT WOULD AFFECT VISIBILITY SUCH AS CURVES, GRADES OR LIMITED SIGHT DISTANCES. DISTANCES CAN BE DECREASED FOR LOW-SPEED (RESIDENTIAL) AREAS. ALL DISTANCES MUST BE APPROVED BY THE STATE OR LOCAL AUTHORITY HAVING JURISDICTION.
 - SHOULDER TAPERS SHOULD BE 1/3 OF THE ON-STREET TAPER LENGTH.
 - MAINTAIN A MINIMUM LANE WIDTH OF 10'.

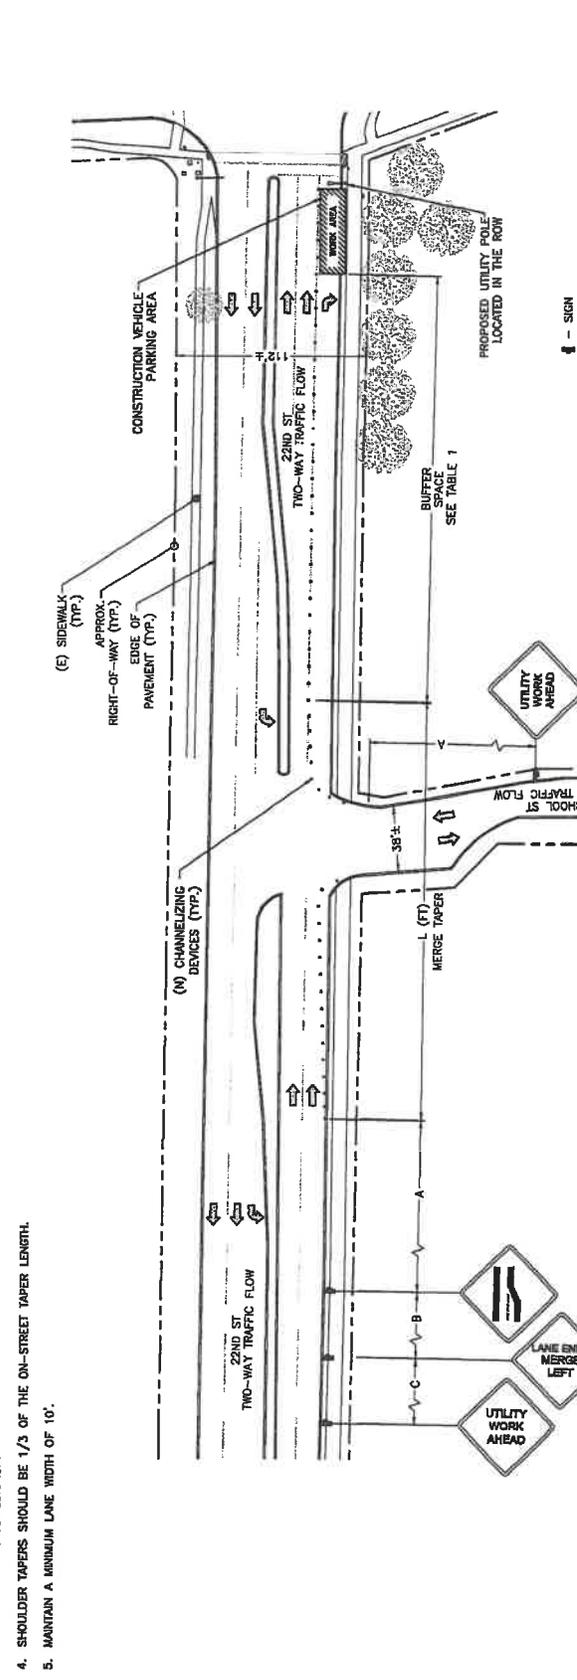


TABLE 1

POSTED SPEED (MPH)	DISTANCE BETWEEN SIGNS			TAPER	BUFFER
	A	B	C		
15	100'	100'	100'	45'	100'
20	100'	100'	100'	65'	100'
25	100'	100'	100'	125'	155'
30	200'	200'	200'	180'	200'
35	200'	200'	200'	245'	250'
40	350'	350'	350'	320'	305'
45	350'	350'	350'	540'	360'
50	500'	500'	500'	600'	425'
55	500'	500'	500'	690'	495'
60	500'	500'	500'	720'	570'
MINIMUM	500'	500'	500'	760'	645'


NOTE: DISTANCES IN FEET UNLESS OTHERWISE NOTED.
 A) CONTRACTOR TO VERIFY EXISTING SPEED LIMIT.
 B) DISTANCES SHOWN ARE NOT VALID FOR LIMITED ACCESS HIGHWAYS. CONSULT STATE DOT MANUAL FOR DISTANCES.
 C) ADJUST DISTANCES TO COMPLY WITH REQUIREMENT OF THE STATE OR LOCAL HIGHWAY AUTHORITY HAVING JURISDICTION. SEE NOTE 1, SHEET TC-2.
 D) TAPER LENGTHS SHOWN BASED ON 12' LANE WIDTH. SEE NOTE 1B, SHEET TC-2.

VEHICULAR TRAFFIC CONTROL PLAN
 SCALE: NOT TO SCALE

PROJECT NO:	ER0007H
DRAWN BY:	F. ABOG
CHECKED BY:	M. BARTOSKY

PRELIM - NOT FOR CONSTRUCTION

A. EXHIBIT 1 REGUL - NOT FOR CONSTRUCTION

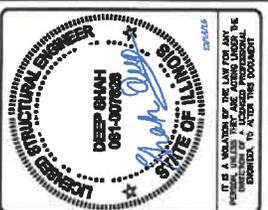

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CHROSTOD
 918N01280
 22ND ST &
 S METERS RD
 LOMBARD, IL 60148
 LIGHT POLE

SHEET TITLE
GENERAL NOTES

SHEET NUMBER
GN-1

- GENERAL CONSTRUCTION NOTES:
 1. ALL WORK SHALL CONFORM TO THE REQUIREMENTS OF THE LOCAL BUILDING CODE, THE LATEST ADOPTED EDITION AND ALL OTHER APPLICABLE CODES AND ORDINANCES.
- CONTRACTOR SHALL CONSTRUCT SITE IN ACCORDANCE WITH THESE DRAWINGS AND LATEST MOBILITE CONSTRUCTION STANDARDS. THE SPECIFICATION IS THE RULING DOCUMENT AND ANY DISCREPANCIES BETWEEN THE SPECIFICATION AND THE DRAWINGS SHALL BE BROUGHT TO THE ATTENTION OF THE ARCHITECT/ENGINEER OR MOBILITE CM PRIOR TO THE COMMENCEMENT OF WORK.
- CONTRACTOR SHALL VISIT THE JOB SITE AND SHALL FAMILIARIZE THEMSELVES WITH ALL CONDITIONS AFFECTING THE (N) WORK AND SHALL MAKE PROVISIONS AS TO THE COMMENCEMENT OF WORK. THE CONTRACTOR SHALL FAMILIARIZE THEMSELVES WITH ALL CONTRACT DOCUMENTS, FIELD CONDITIONS AND DIMENSIONS AND CONFIRMING THAT THE WORK MAY BE ACCOMPLISHED, AS SHOWN, PRIOR TO PROCEEDING WITH CONSTRUCTION. ANY DISCREPANCIES SHALL BE BROUGHT TO THE ATTENTION OF THE ARCHITECT/ENGINEER OR ARCHITECT PRIOR TO THE COMMENCEMENT OF WORK. CONTRACTOR WILL BE AWARDED BASED ON CLARITY OF KNOWLEDGE OF FIELD CONDITIONS.
- IT IS NOT THE INTENT OF THESE PLANS TO SHOW EVERY MINOR DETAIL OF THE WORK. CONTRACTOR SHALL BE RESPONSIBLE FOR THE DEVELOPMENT OF ALL OWNER-SUPPLIED ITEMS. CONTRACTOR SHALL PROVIDE ANY/ALL REQUIREMENTS FOR THE EQUIPMENT TO BE PLACED IN PROPER WORKING ORDER.
- PLANS ARE NOT TO BE SCALED. THESE PLANS ARE INTENDED TO BE A DIAGRAMMATIC OUTLINE ONLY UNLESS OTHERWISE NOTED. THE WORK SHALL INCLUDE FURNISHING MATERIALS, EQUIPMENT AND APPURTENANCES, AND LABOR NECESSARY TO EFFECT ALL INSTALLATIONS AS INDICATED ON THE DRAWINGS, INCLUDING THE INSTALLATION OF MATERIALS WILL INCLUDE THE FOLLOWING, UNLESS NOTED OTHERWISE:
 A) TRANSMITTER
 B) UHF ANTENNA AND MOUNTING BRACKETS, GPS ANTENNAS AND KU ANTENNAS
 C) UHF COAX AND HANGERS
 D) INTEGRATED LOAD CENTER
- DIMENSIONS SHOWN ARE TO FINISH SURFACES UNLESS OTHERWISE NOTED. CRITICAL TO FIELD VERIFY DIMENSIONS. SHOULD THERE BE ANY QUESTIONS REGARDING THE CONTRACT DOCUMENTS, (E) CONDITIONS AND/OR DESIGN INTENT, THE CONTRACTOR SHALL BE RESPONSIBLE FOR REPORTING ANY DISCREPANCIES TO THE ATTENTION OF THE MOBILITE CM IN WRITING, PRIOR TO THE COMMENCEMENT OF WORK.
- DETAILS PROVIDED ARE FOR THE PURPOSE OF SHOWING DESIGN INTENT. MODIFICATIONS MAY BE REQUIRED TO SUIT JOB DIMENSIONS OR SITE CONDITIONS, AND SUCH MODIFICATIONS SHALL BE INCLUDED AS PART OF THE WORK.
- CONTRACTOR SHALL PAY FOR APPLICABLE PERMITS, FEES, INSPECTIONS AND APPROVED SUBMITTALS PRIOR TO ORDERING MATERIALS AND THE COMMENCEMENT OF WORK.
- THE TERM PROVIDED IN CONSTRUCTION DOCUMENTS AND SPECIFICATIONS INDICATES THAT THE CONTRACTOR SHALL FURNISH AND INSTALL.
- CONTRACTOR SHALL RECEIVE CLARIFICATION IN WRITING, AND SHALL RECEIVE IN WRITING AUTHORIZATION TO PROCEED BEFORE STARTING WORK ON ANY ITEMS NOT CLEARLY DEFINED OR IDENTIFIED BY THE CONTRACT DOCUMENTS.
- CONTRACTOR SHALL SUPERVISE AND DIRECT THE WORK USING ACCEPTED CONSTRUCTION METHODS AND ATTENTION. CONTRACTOR SHALL BE SOLELY RESPONSIBLE FOR INSTALLATION AND MAINTENANCE OF THE WORK UNDER CONTRACT, UNLESS OTHERWISE NOTED.
- CONTRACTOR SHALL BE RESPONSIBLE FOR THE SAFETY OF THE WORK AREA ADJACENT AREAS AND BUILDING OCCUPANTS THAT ARE LIKELY TO BE AFFECTED BY THE WORK UNDER THIS CONTRACT. WORK SHALL CONFORM TO ALL OSHA REQUIREMENTS.
- CONTRACTOR SHALL COORDINATE THEIR WORK WITH THE MOBILITE CM AND SCHEDULE THEIR ACTIVITIES AND WORKING HOURS IN ACCORDANCE WITH THE REQUIREMENTS.
- CONTRACTOR SHALL BE RESPONSIBLE FOR COORDINATING THEIR WORK WITH THE ANY OTHER PORTIONS OF THE WORK.
- CONTRACTOR SHALL INSTALL ALL EQUIPMENT AND MATERIALS IN ACCORDANCE WITH MANUFACTURERS RECOMMENDATIONS UNLESS SPECIFICALLY OTHERWISE INDICATED OR WHERE LOCAL CODES OR REGULATIONS TAKE PRECEDENCE.
- CONTRACTOR SHALL MAKE NECESSARY PROVISIONS TO PROTECT (E) SURFACES, EQUIPMENT, IMPROVEMENTS, PIPING ETC. AND IMMEDIATE REPAIR, TO NEW CONSTRUCTION, ANY DAMAGE THAT OCCURS DURING CONSTRUCTION AT THE SOLE COST OF THE CONTRACTOR.
- IN DRILLING HOLES, OR CORING, INTO CONCRETE WHETHER FOR FASTENING OR MORTISING PURPOSES, OR PENETRATIONS THROUGH THE FLOOR FOR CONDUIT RUNNING THROUGH THE FLOOR, CONTRACTOR SHALL BE RESPONSIBLE FOR PROVIDING STEEL SHALL NOT BE DRILLED INTO, CUT OR DAMAGED UNDER ANY CIRCUMSTANCES (UNLESS NOTED OTHERWISE). LOCATIONS OF REINFORCING STEEL ARE NOT DEFINITELY KNOWN AND THEREFORE MUST BE LOCATED BY THE CONTRACTOR USING APPROPRIATE METHODS AND EQUIPMENT PRIOR TO ANY DRILLING OR CORING OPERATIONS IN (E) CONCRETE.
- DAMAGED DURING CONSTRUCTION SUCH THAT THEY MATCH AND BLEND IN WITH ADJACENT SURFACES.
- CONTRACTOR SHALL SEAL PENETRATIONS THROUGH FIRE RATED ASSEMBLIES OR MATERIALS WITH ULL LISTED AND FIRE CODE APPROVED MATERIALS AND NEW PENETRATION IS PLACED.
- CONTRACTOR SHALL KEEP CONTRACT AREA CLEAN, HAZARD FREE, AND DISPOSE OF ALL DEBRIS. ALL SPILLING OR LEAKING OF LIQUID PRESENTS A CLEAN CONDITION AND FREE FROM PAINT SPOTS, DUST, OR SLUDGES OF ANY NATURE. CONTRACTOR SHALL BE RESPONSIBLE FOR MAINTAINING ALL ITEMS UNTIL COMPLETION OF CONSTRUCTION.
- MINIMUM BEND RADIUS OF ANTENNA CABLES SHALL BE IN ACCORDANCE WITH CABLE MANUFACTURERS RECOMMENDATIONS.
- CONTRACTOR SHALL MINIMIZE DISTURBANCE TO (E) SITE DURING CONSTRUCTION. EROSION CONTROL MEASURES, IF REQUIRED DURING CONSTRUCTION SHALL BE IN CONFORMANCE WITH JURISDICTIONAL OR STATE AND LOCAL GUIDELINES FOR EROSION CONTROL. CONTRACTOR SHALL BE RESPONSIBLE FOR MAINTENANCE OF ANY EROSION CONTROL MEASURES, RECORD-KEEPING, MONITORING, AND REPORTING TO THE OWNER AND REGULATORY AUTHORITIES.
- ALL CONSTRUCTION WORK IS TO ADHERE TO APPLICANTS INTEGRATED CONSTRUCTION STANDARDS UNLESS STATE OR LOCAL CODE IS MORE STRINGENT.
- THE INTENT OF THE PLANS AND SPECIFICATIONS IS TO PERFORM THE STATE CODE OF REGULATIONS. SHOULD ANY CONDITIONS DEVELOP NOT COVERED BY THE APPROVED PLANS AND SPECIFICATIONS WHEREIN THE FINISHED WORK DOES NOT MEET THE REQUIREMENTS OF THE WORK, THE CONTRACTOR SHALL BE RESPONSIBLE FOR THE DETAILING AND SPECIFYING THE REQUIRED WORK. SUCH WORK SHALL BE SUBMITTED TO AND APPROVED BY THE JURISDICTION BEFORE PROCEEDING WITH THE WORK. A CHANGE ORDER FOR THAT SCOPE SHALL BE SUBMITTED TO THE MOBILITE CM PRIOR TO PROCEEDING WITH THE WORK.
- ADEQUATE AND REQUIRED LIABILITY INSURANCE SHALL BE PROVIDED BY THE CONTRACTOR FOR THE DURATION OF WORK.
- CONTRACTOR SHALL GUARANTEE ANY/ALL MATERIALS AND WORK FREE FROM DEFECTS FOR A PERIOD OF NOT LESS THAN ONE YEAR FROM DATE OF ACCEPTANCE. ANY CORRECTIVE WORK SHALL BE COMPLETED AT THE SOLE COST OF THE CONTRACTOR.

- ELECTRICAL NOTES:**
- ELECTRICAL CONTRACTOR SHALL SUPPLY AND INSTALL ANY/ALL ELECTRICAL WORK INDICATED. ANY/ALL CONSTRUCTION SHALL BE IN ACCORDANCE WITH OSHA AND ANY/ALL APPLICABLE SPECIFICATIONS. IF ANY PROBLEMS ARE ENCOUNTERED BY COMPLYING WITH THESE REQUIREMENTS, CONTRACTOR SHALL NOTIFY MOBILITE CM AS SOON AS POSSIBLE. AFTER THE DISCOVERY OF THE PROBLEM, CONTRACTOR SHALL IMMEDIATELY STOP WORK AND CONTACT MOBILITE CM. MOBILITE CM HAS DIRECTED THE CORRECTIVE ACTIONS TO BE TAKEN.
 - ELECTRICAL CONTRACTOR SHALL BE RESPONSIBLE FOR THE SAFETY OF THE WORK AREA ADJACENT AREAS AND BUILDING OCCUPANTS THAT ARE LIKELY TO BE AFFECTED BY THE WORK UNDER THIS CONTRACT. WORK SHALL CONFORM TO ALL OSHA REQUIREMENTS.
 - CONTRACTOR SHALL COORDINATE THEIR WORK WITH THE MOBILITE CM AND SCHEDULE THEIR ACTIVITIES AND WORKING HOURS IN ACCORDANCE WITH THE REQUIREMENTS.

ELECTRICAL CONTRACTOR SHALL VISIT THE JOB SITE AND FAMILIARIZE THEMSELVES WITH ANY/ALL CONDITIONS AFFECTING ELECTRICAL AND COMMUNICATIONS INSTALLATION AND MAKE PROVISIONS AS TO THE COST OF CONSTRUCTION. CONTRACTOR SHALL BE RESPONSIBLE FOR THE DEVELOPMENT OF THE FINAL SYSTEM. BID, FAILURE TO COMPLY WITH THIS PARAGRAPH WILL IN NO WAY RELIEVE CONTRACTOR OF PERFORMING ALL WORK NECESSARY FOR A COMPLETE AND WORKING SYSTEM.

ALL WORK SHALL BE PERFORMED IN ACCORDANCE WITH THE LATEST EDITION OF THE NEC, ALL CODES AND ORDINANCES OF THE LOCAL JURISDICTION, AND ALL OTHER APPLICABLE CODES AND ORDINANCES. THE CONTRACTOR SHALL BE RESPONSIBLE FOR OBTAINING ALL NECESSARY PERMITS AND SHALL INCLUDE THE COST OF SUCH PERMITS IN THE BIDDING PRICE. THE CONTRACTOR SHALL BE RESPONSIBLE FOR OBTAINING ALL NECESSARY PERMITS AND SHALL INCLUDE THE COST OF SUCH PERMITS IN THE BIDDING PRICE.

- A) UL - UNDERWRITERS LABORATORIES
- B) NEC - NATIONAL ELECTRICAL CODE
- C) NEMA - NATIONAL ELECTRICAL MANUFACTURERS ASSOC.
- D) OSHA - OCCUPATIONAL SAFETY AND HEALTH ACT
- E) SBC - STANDARD BUILDING CODE
- F) NFPA - NATIONAL FIRE PROTECTION AGENCY
- G) ANSI - AMERICAN NATIONAL STANDARDS INSTITUTE
- H) IEEE - INSTITUTE OF ELECTRICAL AND ELECTRONICS ENGINEERS
- I) ASTM - AMERICAN SOCIETY FOR TESTING MATERIALS

REFER TO SITE PLANS AND ELEVATIONS FOR EXACT LOCATIONS OF ALL EQUIPMENT, AND CONFIRM WITH MOBILITE CM ANY SIZES AND LOCATIONS WHEN NEEDED.

(E) SERVICES: CONTRACTOR SHALL NOT INTERRUPT (E) SERVICES WITHOUT WRITTEN PERMISSION OF THE OWNER.

CONTRACTOR SHALL CONFORM WITH LOCAL UTILITY COMPANY ANY/ALL REQUIREMENTS SUCH AS THE AUG SIZE OF THE CONDUIT, THE SIZE OF TRANSFORMERS, SCHEDULED DOWNTIME FOR THE OWNERS' CONSTRUCTION, ETC. ANY/ALL CONFLICTS SHALL BE BROUGHT TO THE ATTENTION OF THE MOBILITE CM, PRIOR TO BEGINNING ANY WORK.

MINIMUM WIRE SIZE SHALL BE #12 AWG, NOT INCLUDING CONTROL WIRING, UNLESS NOTED OTHERWISE. ALL CONDUCTORS SHALL BE COPPER WITH THIN INSULATION, UNLESS OTHERWISE NOTED.

OUTLET BOXES SHALL BE PRESSED STEEL IN DRY LOCATIONS, CAST ALLOY WITH THREADED HUBS IN WET/DAMP LOCATIONS AND SPECIAL ENCLOSURES FOR OTHER CLASSIFIED AREAS.

IT IS NOT THE INTENT OF THESE PLANS TO SHOW EVERY MINOR DETAIL OF THE CONSTRUCTION. CONTRACTOR IS EXPECTED TO FURNISH AND INSTALL ALL ITEMS FOR A COMPLETE ELECTRICAL SYSTEM AND PROVIDE ALL REQUIREMENTS FOR THE EQUIPMENT TO BE PLACED IN PROPER WORKING ORDER.

ELECTRICAL SYSTEM SHALL BE AS COMPLETELY AND EFFECTIVELY GROUNDED, AS REQUIRED BY SPECIFICATIONS, SET FORTH BY APPLICANT.

ALL WORK SHALL BE PERFORMED BY A LICENSED ELECTRICAL CONTRACTOR IN A FIRST CLASS, WORKMANLIKE MANNER. THE COMPLETED SYSTEM SHALL BE FULLY FUNCTIONAL AND MOBILITE CM SHALL BE APPROVED BY THE MOBILITE CM AND LOCAL ELECTRICAL INSPECTOR. CONTRACTOR SHALL BE RESPONSIBLE FOR OBTAINING ALL NECESSARY PERMITS AND SHALL INCLUDE THE COST OF SUCH PERMITS IN THE BIDDING PRICE.

ALL WORK SHALL BE COORDINATED WITH OTHER TRADES TO AVOID INTERFERENCE WITH THE PROGRESS OF CONSTRUCTION.

ELECTRICAL NOTES - CONT'D.

13. THE CORRECTION OF ANY DEFECTS SHALL BE COMPLETED BY THE CONTRACTOR BEFORE THE COMMENCEMENT OF THE INSTALLATION, WHICH MAY HAVE BEEN DAMAGED THEREBY.
14. CONTRACTOR SHALL PROVIDE AND INSTALL CONDUIT, CONDUITERS, PULL WIRES, BOXES, COVER PLATES AND DEVICES FOR ALL OUTLETS AS INDICATED.
15. DITCHING AND BACK FILL: CONTRACTOR SHALL PROVIDE FOR ALL UNDERGROUND INSTALLED CONDUIT AND EQUIPMENT INSTALLATION AND BACKFILLING AND BACKFILLING. CONTRACTOR REFER TO NOTES AND REQUIREMENTS EXCAVATION, AND BACKFILLING.
16. MATERIALS, PRODUCTS AND EQUIPMENT INCLUDING ALL COMPONENTS THEREOF SHALL BE NEW AND SHALL APPEAR ON THE LIST OF U.S. APPROVED ITEMS AND SHALL MEET OR EXCEED THE REQUIREMENTS OF THE NEC, NEMA AND IEC.
17. CONTRACTOR SHALL SUBMIT SHOP DRAWINGS OR MANUFACTURER'S CATALOG INFORMATION OF ALL/ANY EQUIPMENT AND OTHER ELECTRICAL ITEMS FOR APPROVAL BY THE MOBILITE CM PRIOR TO INSTALLATION.
18. ANY CUTTING OR PATCHING DEEMED NECESSARY FOR ELECTRICAL WORK IS THE RESPONSIBILITY OF THE CONTRACTOR. THE CONTRACTOR SHALL BE RESPONSIBLE FOR THE COST FOR WORK AND PERFORMANCE TO THE SATISFACTION OF THE MOBILITE CM UPON FINAL ACCEPTANCE.
19. THE ELECTRICAL CONTRACTOR SHALL LABEL ALL PANELS WITH ONLY TYPEWRITTEN DIRECTORIES. ALL ELECTRICAL WIRING SHALL BE THE RESPONSIBILITY OF THE ELECTRICAL CONTRACTOR.
20. DISCONNECT SWITCHES SHALL BE UL-RATED, H.P. RATED HEAVY-DUTY, QUICK-MAKE AND QUICK-BREAK ENCLOSURES, AS REQUIRED BY EXPOSURE TYPE.
21. ALL CONDUITS SHALL BE MADE WITH A PROTECTIVE COATING OF AN ANTI-OXIDANT COMPOUND AND SHALL BE PROTECTED FROM MECHANICAL DAMAGE. COAT ALL WIRE SURFACES BEFORE CONNECTING EXPOSED COPPER SURFACES, INCLUDING GROUND BARS, SHALL BE TREATED - NO SUBSTITUTIONS.
22. RACEWAYS: CONDUIT SHALL BE SCHEDULE 80 PVC MEETING OR EXCEEDING NEMA TC2 - 1980A. CONTRACTOR SHALL PLUG AND CAP EACH END OF SPARE AND EMPTY CONDUITS AND PROVIDE TWO SEPARATE PULL STRINGS - 200 LBS TEST POLYETHYLENE CORD. ALL CONDUIT BENDS SHALL BE A MINIMUM OF 2 FT. STEEL ALL FITTINGS SHALL BE SUITABLE FOR USE WITH THREADED RIGID CONDUIT. COAT ALL THREADS WITH "BRITE ZINC" OR "COLD GALV".
23. SUPPORT OF ALL ELECTRICAL WORK SHALL BE AS REQUIRED BY NEC.
24. CONDUITORS: CONTRACTOR SHALL USE 98K CONDUCTIVITY COPPER WITH TYPE WIRING INSULATION, UNLESS OTHERWISE NOTED. 600 VOLT, COLOR CODED, USE SOLID COPPER WIRE, INCLUDING NO. 8 AWG. USE STRANDED CONDUCTORS FOR WIRE ABOVE NO. 8 AWG.
25. CONNECTORS FOR POWER CONDUITORS: CONTRACTOR SHALL USE PRESSURE TIGHT INSULATED MECHANICAL TERMINAL LUGS FOR NO. 8 AWG AND LARGER. USE SOLDERLESS MECHANICAL TERMINAL LUGS FOR NO. 8 AWG AND LARGER.
26. SERVICES AS SPECIFIED ON THE DRAWINGS, OWNER OR OWNER'S AGENT WILL BE RESPONSIBLE FOR OBTAINING ALL NECESSARY PERMITS AND SHALL BE OBTAINED BY THE CONTRACTOR.
27. TELEPHONE OR FIBER SERVICE: CONTRACTOR SHALL PROVIDE EMPTY CONDUITS WITH PULL STRINGS AS INDICATED ON DRAWINGS.
28. ELECTRICAL AND TELCO/FIBER RACEWAYS TO BE BURIED A MINIMUM DEPTH OF 30", UNLESS OTHERWISE NOTED.
29. CONTRACTOR SHALL PLACE 6" WIDE DETECTABLE WARNING TAPE AT A DEPTH OF 6" BELOW GROUND AND DIRECTLY ABOVE ELECTRICAL AND TELCO SERVICE CONDUITS. CAUTIONS TAPE TO READ "CAUTION BURIED ELECTRIC" OR "BURIED TELCO".
30. ALL BOLTS SHALL BE 3-16 STAINLESS STEEL.

GROUNDING NOTES:

1. ALL HARDWARE SHALL BE 3-16 STAINLESS STEEL, INCLUDING LOCK WASHERS. COAT ALL SURFACES WITH AN ANTI-OXIDANT COMPOUND, AS SPECIFIED, BEFORE MATING. ALL HARDWARE SHALL BE STAINLESS STEEL 3/8" INCH DIAMETER OR LARGER.
2. FOR GROUND BOND TO STEEL ONLY: INSERT A CADMIUM FLAT WASHER BETWEEN LUG AND STEEL. COAT ALL SURFACES WITH AN ANTI-OXIDANT COMPOUND BEFORE MATING.
3. ALL STEEL CONDUIT SHALL BE BONDED AT BOTH ENDS WITH GROUNDING BUSHING.
4. ALL ELECTRICAL AND GROUNDING AT THE POLE SITE SHALL COMPLY WITH THE NATIONAL ELECTRICAL CODE (NEC), NATIONAL FIRE PROTECTION ASSOCIATION (NFPA) 780 (LATEST EDITION), AND MANUFACTURER.
5. ALL DETAILS ARE SHOWN IN GENERAL TERMS. ACTUAL GROUNDING INSTALLATION AND CONSTRUCTION MAY VARY DUE TO SITE SPECIFIC CONDITIONS.
6. GROUND ALL ANTENNA BASES, FRAMES, CABLE RINGS, AND OTHER METALLIC COMPONENTS USING #6 GROUND WIRES, FOLLOW ANTENNA AND BITS MANUFACTURER'S PRACTICES FOR GROUNDING REQUIREMENTS.
7. ALL GROUND CONNECTIONS SHALL BE #8 AWG, UNLESS OTHERWISE NOTED. ALL WIRE SHALL BE COPPER WITH THIN, UNLESS OTHERWISE NOTED. ALL GROUND WIRE SHALL BE SOLID TIN COATED OR STRANDED GREEN INSULATED WIRE.
8. CONTRACTOR TO VERIFY AND TEST GROUND, TO REQUIRE, 40 OHMS MAXIMUM PROVIDE SUPPLEMENT GROUNDING RODS AS REQUIRED TO ACHIEVE SPECIFIED OHMS READING. GROUNDING AND OTHER OPTIONAL TESTING WILL BE WITNESSED BY THE MOBILITE CM.
9. NOTIFY ARCHITECT/ENGINEER IF THERE ARE ANY DIFFICULTIES INSTALLING GROUNDING SYSTEM DUE TO SITE SOIL CONDITIONS.
10. ALL HORIZONTALLY RUN GROUNDING CONDUCTORS SHALL BE INSTALLED A MINIMUM OF 30" BELOW GRADE/6" BELOW FLOOR UNLESS OTHERWISE NOTED. BACK FILL SHALL BE COMPACTED AS REQUIRED BY ARCHITECT/ENGINEER.
11. ALL GROUND CONDUCTORS SHALL BE RUN AS STRAIGHT AND SHORT AS POSSIBLE, WITH A MINIMUM 12" BENDING RADIUS NOT LESS THAN 90 DEGREES.
12. ACCEPTABLE CONNECTIONS FOR GROUNDING SYSTEM SHALL BE:
 - A. BURNDY, HY-GRADE U.L. LISTED CONNECTORS FOR OUTDOOR USE OR AS APPROVED BY APPLICANT PROJECT MANAGER.
 - B. CADWELD, EXOTHERMIC WELDS (WELDED CONNECTIONS).
 - C. ONE (1) HOLE THINNED COPPER COMPRESSION (LONG BARREL) FITTINGS.
13. ALL CRIMPED CONNECTIONS SHALL HAVE EMBOSSED MANUFACTURER'S DEWMARK VISIBLE AT THE CRIMP (RESULTING FROM USE OF PROPER CRIMPING DEVICES) AND WEATHER-PROOFED WITH HEAT SHRINK.
14. ALL CONNECTION HARDWARE SHALL BE TYPE 3-16 STAINLESS STEEL (NOT ATTRACTIVE TO MAGNETS).
15. ELECTRICAL SERVICE EQUIPMENT GROUNDING SHALL COMPLY WITH NEC, ARTICLE 250.118. ALL GROUNDING ELECTRODES, NEW OR EXISTING, NEW GROUNDING ELECTRODE SHALL INCLUDE BUT NOT LIMITED TO GROUND RODS.

TESTING AND EQUIPMENT TURN-UP REQUIREMENTS:

1. RF CABLE, DATA CABLE, RADIO EQUIPMENT AND BACK HAUL EQUIPMENT TESTING WILL COMPLY WITH CURRENT INDUSTRY STANDARDS AND OR THOSE STANDARDS OF THE EQUIPMENT MANUFACTURER OR PROVIDED TO THE CONTRACTOR PRIOR TO TESTING.
2. CONTRACTOR WILL USE THE APPROPRIATE CALIBRATED TESTING EQUIPMENT IN RF CABLE, DATA CABLE, RADIO EQUIPMENT AND BACK HAUL EQUIPMENT TESTING. ALL TESTING SHALL BE WITNESSED BY THE MOBILITE CM. STANDARDS PROVIDED TO THE CONTRACTOR PRIOR TO TESTING.

3. CONTRACTOR TO VERIFY AND RECORD ALL TEST RESULTS AND PROVIDE THESE RESULTS WITHIN THE FINAL CLOSE OUT PACKAGE.
4. ALL PERSONNEL INVOLVED IN THE TESTING OF RF CABLE, DATA CABLE, RADIO EQUIPMENT AND BACK HAUL EQUIPMENT SHALL BE TRAINED AND CERTIFIED IN THE PROPER TESTING OF RF CABLE, DATA CABLE, RADIO EQUIPMENT AND BACK HAUL EQUIPMENT.
5. ALL TEST RESULTS SHALL BE TIME STAMPED, RECORDED AND PRESENTED PRIOR TO ENERGIZING AND TURN UP OF ANY EQUIPMENT.
6. GPS EQUIPMENT (WHEN REQUIRED) IS NOT TO BE TESTED OR ATTACHED TO ANY CABLE DURING TESTING, DOING SO WILL DAMAGE THE GPS UNIT.
7. PRIOR TO TESTING IF THE CONTRACTOR HAS ANY QUESTIONS ABOUT THE TESTING PROCEDURES THEY ARE TO CALL AND OBTAIN ASSISTANCE FROM A QUALIFIED DESIGNATED TESTING REPRESENTATIVE.
8. EQUIPMENT IS NOT TO BE ENERGIZED UNTIL ALL TESTING HAS BEEN COMPLETED, APPROVED AND THE APPROPRIATE AUTHORITY HAS BEEN NOTIFIED AND GIVES APPROVAL TO ENERGIZE THE EQUIPMENT.

SITE WORK NOTES:

1. DO NOT EXCAVATE OR DISTURB BEYOND THE PROPERTY LINES OR LEASE LINES, UNLESS OTHERWISE NOTED.
2. SIZE, LOCATION AND TYPE OF ANY UNDERGROUND UTILITIES OR IMPROVEMENTS SHALL BE ACCURATELY NOTED AND PLACED ON AS-BUILT DRAWINGS BY GENERAL CONTRACTOR AND ISSUED TO ARCHITECT/ENGINEER AT COMPLETION OF PROJECT.
3. ALL (E) UTILITIES, FACILITIES, CONDITIONS AND THEIR DIMENSIONS SHOWN ON PLANS HAVE BEEN PLOTTED FROM AVAILABLE RECORDS. THE ENGINEER AND OWNER ASSUME NO RESPONSIBILITY WHATSOEVER AS TO THE SUFFICIENCY OR ACCURACY OF ANY RECORDS. CONTRACTOR SHALL BE RESPONSIBLE FOR THE DETERMINING EXACT LOCATION OF ALL (E) UTILITIES AND FACILITIES PRIOR TO START OF CONSTRUCTION. CONTRACTOR SHALL ALSO OBTAIN FROM EACH UTILITY COMPANY DETAILED INFORMATION RELATIVE TO WORKING SCHEDULES AND METHODS OF REMOVING OR ADJUSTING (E) UTILITIES.

4. CONTRACTOR SHALL VERIFY ALL (E) UTILITIES BOTH HORIZONTALLY AND VERTICALLY PRIOR TO START OF CONSTRUCTION. ANY DISCREPANCIES OR ERRORS AS TO THE INTERPRETATION OF PLANS SHALL BE IMMEDIATELY REPORTED TO THE ARCHITECT/ENGINEER. CONTRACTOR SHALL BE RESPONSIBLE FOR THE INTERPRETATION OF PLANS AND NO FURTHER WORK SHALL BE PERFORMED UNTIL THE DISCREPANCY IS CHECKED AND CORRECTED BY THE ARCHITECT/ENGINEER. FAILURE TO SECURE SUCH INSTRUCTION MEANS CONTRACTOR WILL HAVE WORKED AT THEIR OWN RISK AND EXPENSE. CONTRACTOR SHALL CALL LOCAL UTILITY LOCATIONS PRIOR TO START OF CONSTRUCTION. UTILITY LOCATIONS A MINIMUM OF 48 HOURS PRIOR TO START OF CONSTRUCTION.
5. ALL NEW AND (E) UTILITY STRUCTURES ON SITE AND IN AREAS TO BE CONSTRUCTED SHALL BE SUBJECT TO FINAL INSPECTION AND ELEVATIONS PRIOR TO FINAL INSPECTION OF WORK. ANY COST RELATED TO ADJUSTING (E) STRUCTURES SHALL BE BORNE SOLELY BY THE CONTRACTOR.
6. GRADING OF THE SITE WORK AREA IS TO BE SMOOTH AND CONTINUOUS IN SLOPE AND IS TO FEATHER INTO (E) GRADES AT THE GRADING UNITS.
7. ALL TEMPORARY EXCAVATIONS FOR THE INSTALLATION OF FOUNDATIONS UTILITIES, SHALL BE PROTECTED BY SHIELDING OR BRACING IN ACCORDANCE WITH CORRECT OCCUPATIONAL SAFETY AND HEALTH ADMINISTRATION (OSHA) REQUIREMENTS.

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DRAWN BY:	F. ABOOD
CHECKED BY:	M. RAYBERRY

PRELIM - NOT FOR CONSTRUCTION

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CH1005792D
9L8001128D
22ND ST &
S MEYERS RD
LOMBARD, IL 60148
LIGHT POLE

SHEET TITLE
GENERAL NOTES

SHEET NUMBER
GN-2

IT IS A VIOLATION OF THE LAW FOR ANY PERSON UNLESS THEY ARE A LICENSED PROFESSIONAL ENGINEER, TO SIGN THIS DOCUMENT




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PRELIM - NOT FOR CONSTRUCTION

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IT IS A VIOLATION OF THE LAW FOR ANY PERSON, UNLESS THEY ARE LICENSED UNDER THE PROFESSIONAL ENGINEERING ACT, TO SIGN THE DRAWINGS TO ANY PROJECT.

CH8025782D
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22ND ST &
S MEYERS RD
LOMBARD, IL 60148
LIGHT POLE

SHEET TITLE
GENERAL NOTES

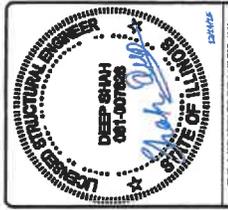SHEET NUMBER
GN-3

- IN AREAS WHICH (E) GRAVEL SURFACING IS REMOVED OR DISTURBED DURING CONSTRUCTION OPERATIONS, REPLACE GRAVEL SURFACING TO MATCH ADJACENT GRAVEL SURFACING AND RESTORED TO THE SAME THICKNESS AND COMPACTION CHARACTERISTICS AND GRAVEL.
- (E) GRAVEL SURFACING MAY NOT BE REUSED.
- GRAVEL SUB SURFACE SHALL BE PREPARED TO REQUIRED COMPACTION AND SUB GRADE ELEVATIONS BEFORE GRAVEL SURFACING IS PLACED AND/OR RESTORED. ANY LOOSE OR DISTURBED MATERIALS SHALL BE THOROUGHLY COMPACTED WITH A WALK-BEHIND VIBRATORY TAMPER. GRAVEL SURFACING MATERIAL SHALL NOT BE USED FOR FILLING DEPRESSIONS IN THE SUB GRADE.
- PROTECT (E) GRAVEL SURFACING AND SUB GRADE IN AREAS WHERE EQUIPMENT LOADS WILL OPERATE. USE PLANKING, MATS OR OTHER SUITABLE PROTECTION TO PREVENT DAMAGE TO (E) GRAVEL SURFACING OR SUB GRADE WHERE SUCH DAMAGE IS DUE TO THE CONTRACTORS OPERATIONS.
- DAMAGE TO (E) STRUCTURES AND/OR UTILITIES RESULTING FROM CONTRACTORS OPERATIONS SHALL BE REPAIRED AND/OR RESTORED TO THE OWNERS SATISFACTION AT NO ADDITIONAL COST TO THE CONTRACT.
- ALL SUITABLE BORROW MATERIAL FOR BACK FILL OF THE SITE SHALL BE OBTAINED FROM A SOURCE APPROVED BY THE ENGINEER. MATERIALS SHALL BE DISPOSED OF OFF SITE AT LOCATIONS APPROVED BY GOVERNING AGENCIES AT NO ADDITIONAL COST TO THE CONTRACT.

- GC TO PLACE FILTER MATERIAL AT ALL CATCH BASINS ADJACENT TO CONSTRUCTION SITE TO PREVENT SOLID WASTE CONTAMINATION FROM ENTERING SEWER SYSTEM
- FOUNDATION, EXCAVATION AND BACKFILL NOTES.
 - ALL FINAL GRADED SLOPES SHALL BE A MAXIMUM OF 3 HORIZONTAL TO 1 VERTICAL, UNLESS OTHERWISE NOTED.
 - BACKFILL OF POLE SHALL BE PERFORMED IN ONE OF TWO OPTIONS:
 - PREFERRED: RAINBOW INDUSTRIES POLE SETTING FOAM SHALL BE INSTALLED PER MANUFACTURERS SPECS. FOAM SHALL ALWAYS BE USED FOR POOR SOILS.
 - SECONDARY: CONCRETE (REQUIRES MOBILE ON WRITTEN APPROVAL) NON-WATABLE SOILS SHALL BE REMOVED FROM BORE AREA AND SHALL NOT BE REUSED FOR BACKFILL.
 - ALL EXCAVATIONS PREPARED FOR PLACEMENT OF CONCRETE SHALL BE OF UNDISTURBED SOILS, SUBSTANTIALLY HORIZONTAL AND FREE FROM ANY LOOSE MATERIALS. EXCESS WATER SHALL BE REMOVED FROM THE EXCAVATION. PROVIDING WATER DETERMINING FOR EXCESS GROUND WATER SHALL BE PROVIDED UNDER REQUIRED. COMPACTION OF SOILS UNDER CONCRETE PAD FOUNDATIONS SHALL NOT BE LESS THAN 98% OF THE MODIFIED PROCTOR MAXIMUM DRY DENSITY FOR THE SOIL IN ACCORDANCE WITH ASTM D1557.
 - CONCRETE FOUNDATIONS SHALL NOT BE PLACED ON ORGANIC OR UNSUITABLE MATERIAL. IF ADEQUATE BEARING CAPACITY IS NOT ACHIEVED AT THE DESIRED FINISH DEPTH AND EITHER BE REPLACED WITH MECHANICALLY COMPACTED GRANULAR MATERIAL OR THE EXCAVATION SHALL BE FILLED WITH CONCRETE OF THE SAME TYPE SPECIFIED FOR THE FOUNDATION. CRUSHED STONE MAY BE USED TO STABILIZE THE BOTTOM OF THE EXCAVATION. ANY STONE SUB BASE IF USED, SHALL NOT SUBSTITUTE FOR REQUIRED THICKNESS OF CONCRETE.
 - ALL EXCAVATIONS SHALL BE CLEAN OF UNSUITABLE MATERIAL SUCH AS VEGETATION, STUMP, DEBRIS, ROCK, FILL OR OTHER MATERIALS. BACK FILL SHALL CONSIST OF APPROVED MATERIALS SUCH AS EARTH, LOAM, SANDY CLAY, SAND AND GRAVEL, OR SOFT SHALE, FREE FROM CLODS OR LARGE STONES OVER 2 1/2" MAX DIMENSIONS. ALL BACK FILL SHALL BE PLACED IN COMPACTED LAYERS.
 - ALL FILL MATERIALS AND FOUNDATION BACK FILL SHALL BE PLACED IN MAXIMUM 6" THICK LIFTS BEFORE COMPACTION. EACH LIFT SHALL BE WETTED IF REQUIRED AND COMPACTION TO NOT LESS THAN 85% OF THE MODIFIED PROCTOR MAXIMUM DRY DENSITY FOR SOIL IN ACCORDANCE WITH ASTM D1557.
 - NEWLY PLACED CONCRETE FOUNDATIONS SHALL CURE A MINIMUM OF 72 HRS PRIOR TO BACK FILLING.
 - FINISHED GRADING SHALL BE SLOPED TO PROVIDE POSITIVE DRAINAGE AND PREVENT STANDING WATER. THE FINAL (FINISH) ELEVATION OF SLAB FOUNDATIONS SHALL SLOPE AWAY IN ALL DIRECTIONS FROM THE CENTER. FINISH GRADE ELEVATIONS SHALL BE SPECIFIED ON THE DRAWINGS. FINISH GRADE ELEVATIONS PROVIDE SURFACE FILL GRAVEL TO ESTABLISH SPECIFIED ELEVATIONS WHERE REQUIRED.
 - NEWLY GRADED GRAVEL SURFACE AREAS TO RECEIVE GRAVEL SHALL BE COVERED WITH GEOTEXTILE FABRIC TYPE: TYPAR-X401 AS MANUFACTURED BY TYPAR GEOSYNTHETICS OR AN APPROVED EQUIVALENT, SHOWN ON PLANS. THE GEOTEXTILE FABRIC SHALL BE BLACK IN COLOR TO CONTROL THE RECURRENT FENCING OR ELECTRICAL GROUNDING SYSTEM PERMITTER WHICH EVER IS GREATER. ALL FABRIC SHALL BE COVERED WITH A MINIMUM OF 4" DEEP COMPACTED STONE OR GRAVEL AS SPECIFIED. I.E. FOOT TYPE NO. 57 FOR FENCED COMPOUND, FOOT TYPE NO. 67 FOR ACCESS DRIVE AREA, UNLESS OTHERWISE NOTED.
 - IN ALL AREAS TO RECEIVE FILL: REMOVE ALL VEGETATION, TOPSOIL, DEBRIS, WET AND UNSATISFACTORY SOIL MATERIALS, OBSTRUCTIONS, AND DELETERIOUS MATERIALS. ALL SURFACES SHALL BE SLOPED TO A MINIMUM OF 4% HORIZONTAL. SURFACES STEEPER THAN 1 VERTICAL TO 4 HORIZONTAL, SUCH THAT FILL MATERIAL WILL BOND WITH (2)/PREPARED SOIL SURFACE.
 - WHERE SUB GRADE OR PREPARED GROUND SURFACE HAS A DENSITY LESS THAN THAT REQUIRED FOR THE FILL MATERIAL, SLOPE THE GROUND SURFACE TO THE DEPTH REQUIRED. PULVERIZE, MOISTURE-CORRECT AND/OR SEPARATE THE SOILS AND RECOMPACT TO THE REQUIRED DENSITY PRIOR TO PLACEMENT OF FILLS.

- SITE WORK NOTES, CONT'D.
- STRUCTURAL FILLS SUPPORTING PAVEMENTS SHALL BE COMPACTED TO 95% OF MAXIMUM STANDARD PROCTOR DRY DENSITY, UNLESS OTHERWISE NOTED.
- NEW GRADES NOT IN BUILDING AND DRIVEWAY IMPROVEMENT AREA TO BE COMPACTED TO 95% OF MAXIMUM STANDARD PROCTOR DENSITY.
- ALL FILL SHALL BE PLACED IN UNIFORM LIFTS. THE LIFTS THICKNESS SHOULD NOT EXCEED 12" UNLESS OTHERWISE NOTED. COMPACTION THROUGHOUT ITS ENTIRE DEPTH WITH THE EQUIPMENT AVAILABLE.
- ANY FILLS PLACED ON (E) SLOPES THAT ARE STEEPER THAN 10 HORIZONTAL TO 1 VERTICAL SHALL BE PROPERLY BENCHED INTO THE (E) SLOPE AS DIRECTED BY A GEOTECHNICAL ENGINEER.
- CONTRACTOR SHALL CLEAN ENTIRE SITE AFTER CONSTRUCTION SUCH THAT NO DEBRIS, WASTE, RUBBER WHEELS, BRUSH, EXCESS FILL OR ANY OTHER DEPOSITS REMAIN ON THE SITE. EXCESS FILL OR OTHER DEPOSITS SHALL BE DISPOSED OF OFF-SITE BY THE GENERAL CONTRACTOR.
- ALL TREES AND SHRUBS WHICH ARE NOT IN DIRECT CONFLICT WITH THE IMPROVEMENTS SHALL BE PROTECTED BY THE GENERAL CONTRACTOR.
- ALL SITE WORK SHALL BE CAREFULLY COORDINATED BY GENERAL CONTRACTOR WITH ALL UTILITIES AND ANY OTHER UTILITY COMPANIES HAVING JURISDICTION OVER THIS LOCATION. ENVIRONMENTAL NOTES.
 - ALL WORK PERFORMED SHALL BE DONE IN ACCORDANCE WITH ISSUED PERMITS. CONTRACTOR SHALL BE RESPONSIBLE FOR PAYMENT OF FINES AND PROPER CLEAN UP FOR AREAS IN VIOLATION.
 - CONTRACTOR SHALL BE RESPONSIBLE FOR CONSTRUCTION AND MAINTENANCE OF EROSION AND SEDIMENTATION CONTROLS DURING CONSTRUCTION FOR PROTECTION OF ADJACENT PROPERTIES, ROADS AND WATERWAYS. ALL EROSION AND SEDIMENTATION CONTROLS SHALL BE MAINTAINED IN PLACE THROUGH FINAL JURISDICTIONAL INSPECTION & RELEASE OF SITE.
 - CONTRACTOR SHALL INSTALL/CONSTRUCT ALL NECESSARY SEDIMENT/SILT CONTROL, FENCING AND PROTECTIVE MEASURES AS REQUIRED BY THE LOCAL JURISDICTION WITHIN THE LIMITS OF SITE DISTURBANCE PRIOR TO CONSTRUCTION.
 - NO SEDIMENT SHALL BE ALLOWED TO EXIT THE PROPERTY. THE CONTRACTOR IS RESPONSIBLE FOR TAKING ADEQUATE MEASURES FOR CONTROLLING EROSION. ADDITIONAL SEDIMENT CONTROL FENCING MAY BE REQUIRED IN ANY AREAS SUBJECT TO EROSION.
 - THE CONTRACTOR IS RESPONSIBLE FOR MAINTAINING POSITIVE DRAINAGE ON THE SITE AT ALL TIMES WITH SILT AND EROSION CONTROL MEASURES MAINTAINED ON THE PROPERTY AS A RESULT OF EROSION WILL BE CORRECTED AT THE CONTRACTORS EXPENSE.
 - CONTRACTOR SHALL BE RESPONSIBLE FOR DAILY INSPECTIONS AND ANY REPAIRS OF ALL SEDIMENT CONTROL MEASURES INCLUDING SEDIMENT REMOVAL AS NECESSARY.
 - CLEARING OF VEGETATION AND TREE REMOVAL SHALL BE ONLY AS PERMITTED AND BE HELD TO A MINIMUM. ONLY TREES NECESSARY FOR CONSTRUCTION OF THE FACILITIES SHALL BE REMOVED.
 - SEEDING AND MULCHING AND/OR SOODING OF THE SITE WILL BE ACCOMPLISHED AS SOON AS POSSIBLE AFTER COMPLETION OF THE PROJECT FACILITIES AFFECTING LAND DISTURBANCE.
 - CONTRACTOR SHALL PROVIDE ALL EROSION AND SEDIMENTATION CONTROL MEASURES AS REQUIRED BY LOCAL, COUNTY AND STATE CODES AND ORDINANCES TO PROTECT EMBANKMENTS FROM SOIL LOGS AND TO PREVENT ACCUMULATION OF SOIL AND SILT IN STREAMS AND DRAINAGE PATHS LEAVING THE PROJECT SITE. CONTRACTOR SHALL MAINTAIN ALL EROSION CONTROL MEASURES AS SILT FENCES, STRAW BALE SEDIMENT BARRIERS, AND CHECK DAMS.
 - 6IP RAP OF SIZES INDICATED SHALL CONSIST OF CLEAN, HARD, SOUND, DURABLE, UNIFORM IN QUALITY STONE FREE OF ANY DETRIMENTAL QUANTITY OF SOFT, FRABLE, THIN, ELONGATED OR LAMINATED PIECES, DISINTEGRATED MATERIAL, ORGANIC MATTER, OIL, ALKALI, OR OTHER DELETERIOUS SUBSTANCES.